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CONSTRUCTION

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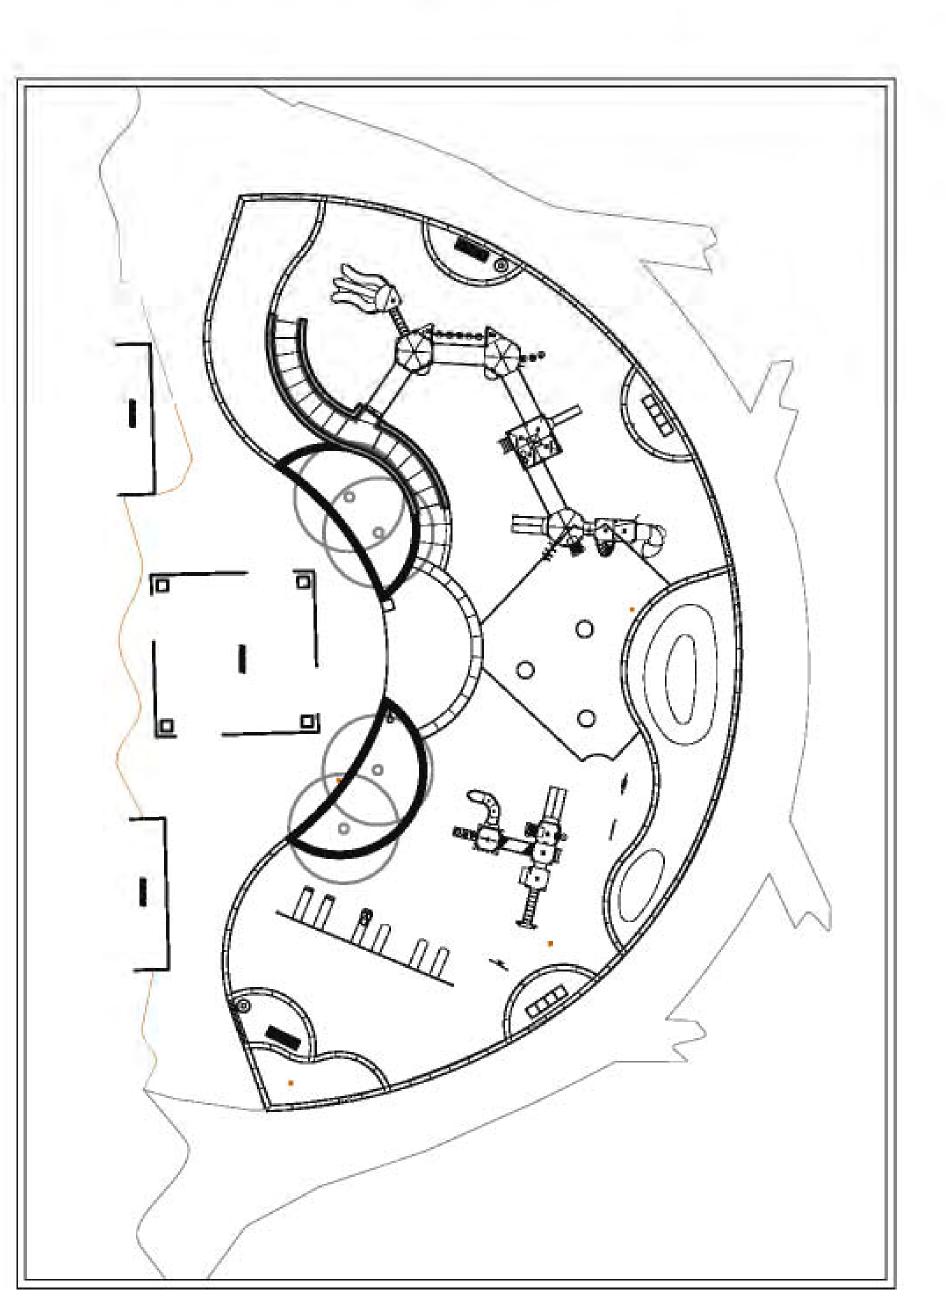
# LRIZ NEV

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rland Park, Illinois



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KEY MAP:

PROJECT SITE

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NORRIS DESIGN

540 Duane Street Glen Ellyn, IL 60137 P 630.547.9372 F 630.790.2204 www.nomis-design.com

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NOTES/SITE AMENITIES SCHEDULE
PLANTING DETAILS & NOTES
GRADING & LAYOUT PLAN
PLAYGROUND PLAN
PLAYGROUND PLAN
PLANTING PLAN & SCHEDULE
DETAILS
DETAILS

KEVIN HERTZ MEMORIAL PLAYGROUND

### CLIENT:

VILLAGE OF ORLAND PARK, RECREATION & PARKS DEPT. ORLAND PARK, IL 708.403.6219 708.403.6289

Owner:

CENTENNIAL PARK

ORLAND PARK, IL

14700 Ravinia Avenue 708.403.6115 Orland Park, IL 60462 VILLAGE OF ORLAND PARK

CONTACT: ELLEN BAER, ASSISTANT VILLAGE MANAGER

### LANDSCAPE ARCHITECTURE:

540 Duane Street Glen Ellyn, Illinois 60137 P 630,547,9372 F 630,790,2204 www.nomis-design.com NORRIS DESIGN
Planning | Landscape Architecture

### ELLEN SCHMIDT

CONTACT: KEITH DEMCHINSKI

### ALTERNATES AND EXCLUSIONS

ALTERNATES

1. CUSTOM FOUL POLE ENTRY MONUMENT, SEE DETAIL 6/L-06

EXCLUSIONS

1. ALL DEMOLITION SHALL BE COMPLETED BY THE VILLAGE OF ORLAND PARK. THE GRADE SHALL BE LEFT AT APPROXIMATELY 12" BELOW FINISHED GRADE AT THE COMPLETION OF DEMOLITION. THE CONTRACTOR SHALL BE RESPONSIBLE FOR ANY COMPACTION AND NECESSARY FILL AND TREE PROTECTION.

2. ALL PLANTING WILL BE COMPLETED IN A SEPARATE CONTRACT EXECUTED BY THE VILLAGE OF ORLAND PARK. THE CONTRACTOR IS NOT RESPONSIBLE FOR SOIL PREPARATION, AMENDMENTS, OR PLANTING. THE CONTRACTOR SHALL LEAVE ALL PLANTING AREAS FREE OF CONSTRUCTION DEBRIS AND SPOILS, CLEAN TOPSOIL SHALL BE ADDED TO BRING THE PLANTING BEDS UP TO 12" BELOW FINISHED GRADE IF NEEDED.

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CONCRETE EDGES, SAW CUTS AND/OR TOWELED SCORE JOINTS SHALL BE CRISP, CLEAN, COMPLETE AND NEAT IN APPEARANCE. LOCATE ALL JOINTS AS IDENTIFIED ON THE PLANS OR AS DIRECTED BY THE OWNER'S REPRESENTATIVE.

ALL EXPOSED PAVING SHALL BE FINISHED PER DETAILS.

CONTRACTOR SHALL PROVIDE ALL PROTECTION AND FACILITIES NECESSARY TO INSURE PROPER CURING AND FINISH OF PAVING.

ONSTRUCTION (CONSTRUCTION)

### GENERAL NOTES

- CONTRACTOR SHALL VISIT THE SITE TO GET A BETTER UNDERSTANDING OF THE PROJECT PRIOR TO BIDDING THE PROJECT.
   THESE PLANS SHALL NOT BE UTILIZED FOR CONSTRUCTION OR PERMITTING UNLESS STATED FOR SUCH USE IN THE TITLE BLOCK.
   DRAWINGS ARE INTENDED TO BE PRINTED ON 24"x36" PAPER. PRINTING THESE DRAWINGS AT A DIFFERENT SIZE WILL IMPACT THE SCALE. VERIFY THE GRAPHIC SCALE BEFORE REFERENCING ANY MEASUREMENTS ON THESE SHEETS. THE RECIPIENT OF THESE DRAWINGS SHALL BE RESPONSIBLE FOR ANY ERRORS RESULTING FROM INCORRECT PRINTING, COPYING, OR ANY OTHER CHANGES THAT ALTER THE SCALE OF THE DRAWINGS.
   VERIFY ALL PLAN DIMENSIONS PRIOR TO START OF CONSTRUCTION. NOTIFY THE OWNER'S REPRESENTATIVE TO ADDRESS ANY QUESTIONS OR CLARIFY ANY DISCREPANCIES.
   WRITTEN DIMENSIONS TAKE PRECEDENCE OVER SCALED DIMENSIONS.
   WRITTEN DIMENSIONS TAKE PRECEDENCE OVER SCALED DIMENSIONS.
   SUBMIT A CHANGE ORDER FOR APPROVAL FOR ANY CHANGES TO WORK SCOPE RESULTING FROM FIELD CONDITIONS OR DIRECTION BY OWNER'S REPRESENTATIVE WHICH REQUIRE ADDITIONAL COST TO THE OWNER PRIOR TO PERFORMANCE OF WHICH REQUIRE ADDITIONAL COST TO THE OWNER PRIOR TO PERFORMANCE OF

- THE CONTRACTOR SHALL PROVIDE A STAKED LAYOUT OF ALL SITE IMPROVEMENTS
  FOR INSPECTION BY THE OWNER'S REPRESENTATIVE AND MAKE MODIFICATIONS AS
  REQUIRED. ALL LAYOUT INFORMATION IS AVAILABLE IN DIGITAL FORMAT FOR USE BY
  THE CONTRACTOR.

  8. CONTRACTOR SHALL CONFIRM THAT SITE CONDITIONS ARE SIMILAR TO THE PLANS,
  WITHIN TOLERANCES STATED IN THE CONTRACT DOCUMENTS, AND SATISFACTORY TO
  THE CONTRACTOR PRIOR TO START OF WORK. SHOULD SITE CONDITIONS BE
  DIFFERENT THAN REPRESENTED ON THE PLANS OR UNSATISFACTORY TO THE
  CONTRACTOR, THE CONTRACTOR SHALL CONTACT THE OWNER'S REPRESENTATIVE
  FOR CLARIFICATION AND FURTHER DIRECTION.

  9. CONTRACTOR IS RESPONSIBLE TO PAY FOR, AND OBTAIN, ANY REQUIRED
  APPLICATIONS, PERMITTING, LICENSES, INSPECTIONS AND METERS ASSOCIATED WITH

- 10. THE CONTRACTOR SHALL BE RESPONSIBLE FOR ANY FINES OR PENALTIES ASSESSED TO THE OWNER RELATING TO ANY VIOLATIONS OR NON-CONFORMANCE WITH THE PLANS, SPECIFICATIONS, CONTRACT DOCUMENTS, JURISDICTIONAL CODES, AND REGULATORY AGENCIES.

  11. THE CONTRACTOR SHALL BE RESPONSIBLE FOR COORDINATION OF ALL UTILITY LOCATES PRIOR TO ANY EXCAVATION. NOTIFY OWNER'S REPRESENTATIVE IF EXISTING OR PROPOSED UTILITIES INTERFERE WITH THE ABILITY TO PERFORM WORK.

  12. UNLESS IDENTIFIED ON THE PLANS FOR DEMOLITION OR REMOVAL, THE CONTRACTOR IS RESPONSIBLE FOR THE COST TO REPAIR UTILITIES, ADJACENT OR EXISTING LANDSCAPE, ADJACENT OR EXISTING PAVING, OR ANY PUBLIC AND PRIVATE PROPERTY THAT IS DAMAGED BY THE CONTRACTOR OR THEIR SUBCONTRACTOR'S OPERATIONS DURING INSTALLATION, ESTABLISHMENT OR DURING THE SPECIFIED MAINTENANCE PERIOD. ALL DAMAGES SHALL BE REPAIRED TO PRE-CONSTRUCTION CONDITIONS AS DETERMINED BY THE OWNER'S REPRESENTATIVE. CONTRACTOR SHALL BE RESPONSIBLE FOR LOGGING ANY DAMAGES PRIOR TO START OF CONSTRUCTION AND DURING THE CONTRACT PERIOD.

  13. ALL WORK SHALL BE CONFINED TO THE AREA WITHIN THE CONSTRUCTION LIMIT'S AS SHOWN ON THE PLANS. ANY AREAS OR IMPROVEMENTS DISTURBED OUTSIDE THESE LIMITS SHALL BE RETURNED TO THEIR ORIGINAL CONDITION AT THE CONTRACTOR'S EXPENSE. IN THE EVENT THE CONTRACTOR REQUIRES A MODIFICATION TO THE CONSTRUCTION LIMIT'S, WRITTEN PERMISSION MUST BE OBTAINED FROM THE OWNER'S REPRESENTATIVE PRIOR TO ANY DISTURBANCE OUTSIDE OF THE LIMITS OF WORK
- 14. THE CONTRACTOR SHALL BE RESPONSIBLE FOR THE REPAIR OF ANY OF THEIR TRENCHES OR EXCAVATIONS THAT SETTLE, INCLUDING ALL IRRIGATION DITCHES.

  15. THE CONTRACTOR SHALL BE RESPONSIBLE TO PREPARE AND SUBMIT A TRAFFIC CONTROL PLAN TO THE APPROPRIATE JURISDICTIONAL AGENCIES AND THE OWNER'S REPRESENTATIVE IF THEIR WORK AND OPERATIONS AFFECT OR IMPACT THE PUBLIC RIGHTS-OF-WAY. OBTAIN APPROVAL PRIOR TO ANY WORK WHICH AFFECTS OR IMPACTS THE PUBLIC RIGHTS-OF-WAY. THE CONTRACTOR SHALL BE RESPONSIBLE FOR ANY FINES OR PENALTIES ASSESSED TO THE OWNER RELATING TO THIS REQUIREMENT DURING THE CONTRACT PERIOD.

  16. SIGHT TRIANGLES AND SIGHT LINES SHALL REMAIN UNOBSTRUCTED BY EQUIPMENT, CONSTRUCTION MATERIALS, PLANT MATERIAL OR ANY OTHER VISUAL OBSTACLE DURING THE CONTRACT PERIOD AND AT MATURITY OF PLANTS PER LOCAL JURISDICTIONAL REQUIREMENTS. NO PLANT MATERIAL OTHER THAN GROUND COVER IS ALLOWED TO BE PLANTED ADJACENT TO FIRE HYDRANTS AS STIPULATED BY JURISDICTIONAL REQUIREMENTS.

- 17. COORDINATE SITE ACCESS, STAGING, STORAGE AND CLEANOUT AREAS WITH OWNER'S REPRESENTATIVE.

  18. CONTRACTOR IS RESPONSIBLE FOR PROVIDING TEMPORARY SAFETY FENCING AND BARRIERS AROUND ALL IMPROVEMENTS SUCH AS WALLS, PLAY STRUCTURES, EXCAVATIONS, ETC. ASSOCIATED WITH THEIR WORK UNTIL SUCH FACILITIES ARE COMPLETELY INSTALLED PER THE PLANS, SPECIFICATIONS AND MANUFACTURER'S RECOMMENDATIONS.

  19. CONTRACTOR SHALL BE RESPONSIBLE FOR PROTECTION OF THEIR MATERIAL STOCK PILES AND WORK FROM VANDALISM, EROSION OR UNINTENDED DISTURBANCE DURING

- PILES AND WORK FROM VANDALISM, EROSION OR UNITIENDED DISTURBANCE DURING THE CONSTRUCTION PERIOD AND UNTIL FINAL ACCEPTANCE IS ISSUED.

  20. THE CONTRACTOR SHALL PROVIDE A STORM WATER POLLUTION PREVENTION PLAN BEFORE PERFORMANCE OF ANY SITE WORK. THE CONTRACTOR SHALL KNOW, UNDERSTAND AND ABIDE BY ANY STORM WATER POLLUTION PREVENTION PLAN (SWPPP) ASSOCIATED WITH THE SITE. EXISTING CATCH BASINS SHALL BE PROTECTED WITH EROSION CONTROL FENCING TO BE MAINTAINED THROUGHOUT THE PROJECT BY THE CONTRACTOR.

  21. MAINTAIN ANY STORM WATER MANAGEMENT FACILITIES THAT EXIST ON SITE FOR FULL FUNCTIONALITY. THE CONTRACTOR SHALL INSTALL AND MAINTAIN ANY NEW STORM WATER MANAGEMENT FACILITIES THAT ARE IDENTIFIED IN THE SCOPE OF WORK TO FULL FUNCTIONALITY. THE CONTRACTOR SHALL INSTALL AND MAINTAIN ANY NEW STORM WATER MANAGEMENT FACILITIES THAT ARE IDENTIFIED IN THE SCOPE OF WORK TO FULL FUNCTIONALITY. THE CONTRACTOR SHALL BE RESPONSIBLE FOR ANY LIFE ON MAINTAIN STORM WATER MANAGEMENT FACILITIES DURING THE CONTRACT PERIOD.

  22. THE CONTRACTOR SHALL PREVENT SEDIMENT, DEBRIS AND ALL OTHER POLLUTANTS FROM EXITING THE SITE OR ENTERING THE STORM SEWER SYSTEM DURING ALL DEMOLITION OR CONSTRUCTION OPERATIONS THAT ARE PART OF THIS PROJECT. THE CONTRACTOR SHALL BE RESPONSIBLE FOR ANY FINES OR PERIALTIES ASSESSED TO THE OWNER RELATING TO THESE REQUIREMENTS DURING THEIR CONTRACTED CONTRACTED CONTRACTOR SHALL BE RESPONSIBLE FOR ANY FINES OR PENALTIES ASSESSED TO THE OWNER RELATING TO THESE STANDARDS DURING THEIR CONTRACTED COURSE OF WORK.

  24. THE CONTRACTOR ANDOR THEIR ANTHORIZED AGENTS SHALL USURE THAT ALL LOADS OF CONSTRUCTION MATERIAL IMPORTED TO OR EXPORTED FROM THE PROJECT SHALL BE PROPERLY COVERED TO PREVENT LOSS OF MATERIAL DURING TRANSPORT. TRANSPORTATION METHODS ON PUBLIC RIGHT-OF WAYS SHALL CONFORM TO JURISDICTIONAL REQUIREMENTS. THE CONTRACTOR SHALL BE RESPONSIBLE FOR ANY FINES OR PENALTIES ASSESSED TO THE OWNER RELATING TO THE SHALL BE PROPERLY COVERED TO PREVENT LOSS OF MATERIAL DURING TRANSPORT. TRANSPORTATION METHODS ON PUBLIC RIG
- THESE REQUIREMENTS.

  25. THE DISCHARGE OF WATER, WASTE CONCRETE, POLLUTANTS, OR OTHER MATERIALS SHALL ONLY OCCUR IN AREAS DESIGNED FOR SUCH USE AND APPROVED BY THE OWNER'S REPRESENTATIVE.

  26. OPEN SPACE SWALES: IF SWALES ARE EXISTING ON SITE AND ARE NOT INTENDED TO BE MODIFIED AS PART OF THE PLANS, THE CONTRACTOR SHALL BE RESPONSIBLE TO MAINTAIN THE CONVEYANCE OF WATER WITHIN THE SWALES DURING THE CONTRACT PERIOD. THE CONTRACTOR SHALL BE RESPONSIBLE FOR ANY DIVERSION OR PUMPING OF WATER IF REQUIRED TO COMPLETE WORK. ANY SWALES DISTURBED BY THE CONTRACTOR SHALL BE REPAIRED/RESTORED TO THEIR ORIGINAL CONDITION. IF THE SWALE NEEDS TO BE DISTURBED OR MODIFIED FOR ANY REASON, THE CONTRACTOR SHALL NOTIFY THE OWNER'S REPRESENTATIVE FOR APPROVAL PRIOR TO DISTURBANCE.
- 27. DETENTION AND WATER QUALITY PONDS: IF DETENTION PONDS AND WATER QUALITY PONDS ARE EXISTING ON SITE AND ARE NOT INTENDED TO BE MODIFIED AS PART OF THE PLANS, THE CONTRACTOR SHALL MINIMIZE DISTURBANCE TO THE PONDS, DRAINAGE STRUCTURES AND SPILLWAYS DURING CONSTRUCTION. ALL PONDS, DRAINAGE STRUCTURES AND SPILLWAYS SHALL BE MAINTAINED IN OPERABLE CONDITIONS AT ALL TIMES. ANY POND OR SPILLWAY AREAS DISTURBED BY THE CONTRACTOR SHALL BE REPAIRED/RESTORED TO THEIR ORIGINAL CONDITION. IF THE POND NEEDS TO BE DISTURBED OR MODIFIED FOR ANY REASON, THE CONTRACTOR SHALL NOTIFY THE OWNER'S REPRESENTATIVE FOR APPROVAL PRIOR TO
- DISTURBANCE.

  VILLAGE OF ORLAND PARK TO ABANDON AND REM
  ASSOCIATED DRAINAGE PIPE TO APPROXIMATE LC
  SHOWN ON L-03. IOVE 2 EXISTING CATCH BASINS AND CATION OF DRAINAGE CLEANOUTS

### FURNITURE / PLAYGROUND NOTES

- CONTRACTOR SHALL ASSURE THAT ALL FASTENERS ARE TIGHT, PROTRUDING BOLTS ARE TRIMMED FLUSH AND PENNED, FILING SMOOTH ANY RESULTANT SHARP METAL EDGES OF ALL PLAYGROUND FEATURES, SITE FURNITURE AND SITE
- AMENITIES.

  2. CONTRACTOR IS RESPONSIBLE FOR SECURING PLAYGROUND ELEMENTS UNTIL INSTALLATION OF SAFETY SURFACING AND INITIAL ACCEPTANCE OF PLAYGROUND ELEMENTS IS GRANTED.

  3. CONTRACTOR SHALL PROVIDE STRUCTURAL FOOTING DESIGN FOR ALL SITE FEATURE ELEMENTS IF STRUCTURAL FOOTING DESIGNS ARE NOT PROVIDED BY A LICENSED STRUCTURAL ENGINEER AS PART OF THESE PLANS.

  4. PLAYGROUND INSTALLATION SHALL BE CERTIFIED FOR SAFETY BY AN IPEMA PROFESSIONAL PRIOR TO INITIAL ACCEPTANCE. CONTRACTOR SHALL PROVIDE DOCUMENTATION OF INSPECTION AND APPROVAL AS PART OF THE PROJECT TURN-OVER ITEMS.

### GENERAL GRADING NOTES

NORRIS DESIGN

- 1. PRELIMINARY AND FINAL GRADES SHALL BE ESTABLISHED BY THE CONTRACTOR. IF EXISTING CONDITIONS DIFFER FROM WHAT IS INDICATED ON THE SURVEY, NOTIFY THE OWNER'S REPRESENTATIVE PRIOR TO PROCEEDING WITH WORK.

  2. THE CONTRACTOR IS TO ADHERE TO SPOT ELEVATIONS AND CONTOURS AS INDICATED ON THE GRADING PLAN UNLESS SPECIFICALLY AUTHORIZED BY THE OWNER'S REPRESENTATIVE.

  3. ALL AREAS SHALL BE GRADED TO ACHIEVE POSITIVE DRAINAGE.

  4. EXCAVATION INCLUDES ALL MATERIAL ENCOUNTERED TO WHATEVER DEPTH INDICATED ON THE PLANS. EXCAVATE TO ALLOW FOR PROPER FILL MATERIAL, SLABS, VOIDS, FORMS, AND FOUNDATIONS.

  5. CALL UTILITY LOCATORS PRIOR TO START OF ANY REMOVALS OR CONSTRUCTION. THE CONTRACTOR IS RESPONSIBLE FOR THE COST TO REPAIR ANY UTILITIES OR EXISTING SITE FEATURES DAMAGED DUE TO CONSTRUCTION ACTIVITIES.

  6. REFER TO SPECIFICATIONS FOR FURTHER INFORMATION REGARDING GRADING AND EXCAVATION FOR THIS PROJECT.

  7. WHEN MOISTURE CONTENT AND CONDITIONS OF EACH SPREAD LAYER ARE SATISFACTORY, COMBACT BEB SECURIORS.

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### SITE AMENITIES SCHEDULE

KEVIN HERTZ MEMORIAL PLAYGROUND

ITEM	DESCRIPTION	MANUFACTURER	CONTACT	MODEL NUMBER	COLOR	NOTES
$\Leftrightarrow$	BENCH*	DUMOR	NUTOYS KEVIN DRISCOLL 708.579.9055	BENCH 164-60 (QUANTITY OF 2)	GREEN	SURFACE MOUNT, INSTALL PER MANUFACTURER'S SPECIFICATIONS
<b>⊗</b>	STADIUM SEATS*	AMERICAN SEATING		AMERICAN SEATING MODEL: 505-P (QUANTITY OF 8)	DARK GREEN	SURFACE MOUNT, INSTALL PER MANUFACTURER'S SPECIFICATIONS
<b>⇔</b>	PLAYGROUND FENCE	AMERISTAR	ERIC RUD 847.612.3124	MONTAGE PLUS MAJESTIC STYLE 4" TALL	BLACK	INSTALL PER MANUFACTURER'S SPECIFICATIONS
<b>③</b>	TRASH RECEPTACLE*	DUMOR	NUTOYS KEVIN DRISCOLL 708.579.9055	87-22 (QUANTITY OF 2)	GREEN	SURFACE MOUNT, INSTALL PER MANUFACTURER'S SPECIFICATIONS
<b>©</b>	POURED IN PLACE SURFACING	KIDTUFF	TOTAL SURFACE ERICK OLESON 847-657-0808		80% TAN 20% DARK GRAY SURFACE PADS: TAN	
<b>③</b>	X-GRASS SAFETY SURFACING	X-GRASS PLAY	CUNNINGHAM RECREATION GARRY GRAHAM 800.942,1062			INCLUDE GRASS ENVIROFILL, INSTALL PER MANUFACTURER'S SPECIFICATIONS
<b>\oint </b>	CONCRETE PAVERS	UNILOCK	UNILOCK AUGGIE RODRIGUEZ 630.892.9191	HOLLAND PREMIER 7.8x3.9x2.73	SIERRA	
•	36" DIA CUSTOM CONCRETE BASEBALL STRUCTURES	WAUSAU TILE	WAUSAU TILE 800.388.8728		CUSTOM: WHITE WITH RED STITCHING	CONTRACTOR TO PROVIDE SHOP DRAWINGS FOR APPROVAL
•	SWING STRUCTURE*	LANDSCAPE STRUCTURES	NUTOYS KEVIN DRISCOLL 708.579.9055			INSTALL PER MANUFACTURER'S SPECIFICATIONS
<b>③</b>	2-5 YEAR OLD PLAY STRUCTURE*	LANDSCAPE STRUCTURES	NUTOYS KEVIN DRISCOLL 708.579.9055			INSTALL PER MANUFACTURER'S SPECIFICATIONS
\$	5-12 YEAR OLD PLAY STRUCTURE*	LANDSCAPE STRUCTURES	NUTOYS KEVIN DRISCOLL 708.579.9055			INSTALL PER MANUFACTURER'S SPECIFICATIONS
€	SAFETY TILES		TOTAL SURFACE ERICK OLESON 847-657-0808	2'X2' TILE TO MEET ALL SAFETY STANDARDS	SURFACE PADS: TAN TO MATCH POURED IN PLACE	
<b>\$</b>	ALTERNATE: CUSTOM FOUL POLE SIGN	CUSTON	MERCEDES FABRICATION 708.709.9240 OR APPROVED EQUAL		DARK GREEN - SUBMIT SAMPLE FOR APPROVAL	CONTRACTOR TO PROVIDE SHOP DRAWINGS FOR APPROVAL

VILLAGE OF ORLAND PARK, RECREATION & PARKS DEPT. ORLAND PARK, IL 708.403.6219 708.403.6289

Owner:

CENTENNIAL PARK

ORLAND PARK, IL

ITEM TO BE PURCHASED BY THE VILLAGE, CONTRACTOR RESPONSIBLE FOR INSTALLATION

1. THE CONTRACTOR SHALL INSTALL OR COORDINATE INSTALLATION OF SLEEVING
FOR IRRIGATION AND UTILITY IMPROVEMENTS PRIOR TO INSTALLING ALL PAVING.
REFER TO IRRIGATION AND UTILITY PLANS FOR SIZE AND LOCATIONS.
CONTRACTOR SHALL COORDINATE AND BE RESPONSIBLE FOR ALL SUB-GRADE
COMPACTION UNDER PAVED AREAS. REFER TO PLANS, DETAILS, SPECIFICATIONS
OR GEOTECHNICAL REPORTS WHICH IDENTIFY COMPACTION REQUIREMENTS.
COORDINATE ALL COMPACTION TESTING WITH OWNER'S REPRESENTATIVE.
CONTRACTOR SHALL BE FINANCIALLY RESPONSIBLE FOR THE REPLACEMENT OF
ANY PAVING THAT CRACKS OR MOVES RESULTING FROM IMPROPER COMPACTION.
CURVED WALKS AND CURB EDGES ARE INTENDED TO BE CONSTRUCTED WITH
SMOOTH FLOWING CURVES. ANYTHING OTHER THAN SMOOTH FLOWING CURVES
WILL BE REJECTED AS DETERMINED BY THE OWNER'S REPRESENTATIVE.
LAYOUT ALL SURFACING, SCORE JOINTS AND PAVING PATTERNS AS CLOSELY AS
POSSIBLE TO PLANS, DETAILS, AND SPECIFICATIONS. DO NOT DEVIATE FROM PLANS
UNLESS SPECIFIC APPROVAL IS OBTAINED FROM THE OWNER'S REPRESENTATIVE.
CONTRACTOR SHALL COORDINATE A FORM INSPECTION WITH THE OWNER'S
REPRESENTATIVE NO LESS THEN 24 HOURS PRIOR TO PLACEMENT OF ANY
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CLARIFICATION.
THE CONTRACTOR SHALL OBTAIN, AT HIS EXPENSE, ALL NECESSARY TO PERFORM THE PROPOSED WORK.

PERMITS WHICH ARE

WRITTEN DIMENSIONS WILL TAKE PRECEDENCE OVER SCALED DIMENSIONS. SHOULD SITE CONDITIONS BE DIFFERENT THAN WHAT IS INDICATED ON THE DRAWINGS CONTACT THE LANDSCAPE ARCHITECT IMMEDIATELY FOR

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12. THE CONTRACTOR SHALL PROVIDE A STAKED LAYOUT OF ALL SITE IMPROVEMENTS FOR INSPECTION BY THE OWNER'S REPRESENTATIVE AND MAKE MODIFICATIONS AS REQUIRED AT NO ADDITIONAL COST TO THE OWNER.

14. ALL WORK SHALL BE CONFINED TO THE AREA WITHIN THE CONSTRUCTION LIMITS AS SHOWN ON THE PLANS. ANY AREAS OR IMPROVEMENTS DISTURBED OUTSIDE THESE LIMITS SHALL BE RETURNED TO THEIR ORIGINAL CONDITION AT THE CONTRACTOR'S EXPENSE. IN THE EVENT THE CONTRACTOR REQUIRES A MODIFICATION TO THE CONSTRUCTION LIMITS, WRITTEN PERMISSION MUST BE OBTAINED FROM THE LANDSCAPE ARCHITECT PRIOR TO ANY DISTURBANCE OUTSIDE OF THE LIMITS OF WORK. SEE TECHNICAL SPECIFICATIONS.

16. CONTRACTOR IS RESPONSIBLE FOR SUPERVISING ALL PAVEMENT DURING THE

CURING PROCESS. ALL STANDARD CONCRETE FLATWORK SHALL BE 4" THICK AND REINFORCED WITH WWM OR REBAR AS REQUIRED.

PAVING LAYOUT NOTES

NOTE:
ALL SITE AMENITY LOCATIONS SHALL BE APPROVED IN
THE FIELD BY THE OWNER'S REPRESENTATIVE PRIOR TO
FINAL PLACEMENT



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NOTES / SITE

Sheet Title

Revision Date

8/6/12 Bid Set

Issue Date

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TREE.

PLANTING DETAIL

ROOT BALL DIAMETER

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### FOR CONSTRUCTION

PERENNIAL PLANT LAYOUT 2X CONTAINER WIDTH O.C. SPACING (ω (2) SET SHRUB ROOT-BALL 1" HIGHER THAN FINISH BED GRADE PRUNE ALL DEAD OR DAMAGED WOOD PRIOR TO PLANTING (2) WHEN PLANTED ON A CURVE ORIENT ROWS TO FOLLOW THE LONG AXIS OF AREAS WHERE PLANTS ARE MASSED. BROKEN OR CRUMBLING
ROOT-BALLS WILL BE REJECTED
CARE SHOULD BE TAKEN NOT TO
DAMAGE THE SHRUB OR
ROOT-BALL WHEN REMOVING IT FROM ITS CONTAINER
ALL JUNIPERS SHOULD BE
PLANTED SO THE TOP OF TH ROOT-BALL OCCURS ABOVE THE FINISH GRADE OF THE MULCH DIG PLANT PIT TWICE AS WIDE AND HIGH AS THE CONTAINER FINISH GRADE (TOP OF MULCH) CENTER OF PLANT AMENDED PLANTING BED PER SPECIFICATIONS TILLED TO A DEPTH OF 6" SPECIFIED MULCH AMENDED SOIL IN PLANTING BED PER SPECIFICATIONS. TILL SOIL TO A DEPTH OF EIGHT INCHES. SPECIFIED MULCH 1" = 1'-0" 盂

CHIM SHITHN FEEL PLAN VIEW  $\bigcirc$ - THREE STAKES (O) STAKING I 1. STAP OLLOWS

SHRUB PLANTING

SCALE: 1-1/2" = 1'-0"

PRUNING NOTES:

1. ALL PRUNING SHALL COMPLY WITH ANSI A300 STANDARDS.

2. DO NOT HEAVILY PRUNE THE TREE AT PLANTING. PRUNE ONLY CROSSOVER LIMBS, CO-DOMINANT LEADERS AND BROKEN BRANCHES. SOME INTERIOR TWIGS AND LATERAL BRANCHES MAY BE PRUNED. HOWEVER, DO NOT REMOVE THE TERMINAL BUDS OF BRANCHES THAT EXTEND TO THE EDGE OF THE CROWN.

NOTES: KE TREES PER FOLLOWING SCHEDULE, THEN REMOVE AT END OF FIRST GROWING SEASON.

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PLANT TREE SO THAT FIRST ORDER MAJOR ROOT IS 1"-2" ABOVE FINAL GRADE.

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1.1  $1\frac{1}{2}$ " CALIPER SIZE - MIN. 1 STAKE ON SIDE OF PREVAILING WIND (GENERALLY N.W. SIDE) 1.2  $1\frac{1}{2}$ " - 3" CALIPER SIZE - MIN. 2 STAKES - ONE ON N.W. SIDE, ONE ON S.W. SIDE (OR PREVAILING WIND SIDE AND 180° FROM THAT SIDE) 1.3 3" CALIPER SIZE AND LARGER - 3 STAKES PER DIAGRAM WIRE OR CABLE SHALL BE MIN. 12 GAUGE, TIGHTEN WIRE OR CABLE ONLY ENOUGH TO KEEP FROM SLIPPING. ALLOW FOR SOME TRUNK MOVEMENT. NYLON STRAPS SHALL BE LONG ENOUGH TO ACCOMMODATE  $1\frac{1}{2}$ " OF GROWTH AND BUFFER ALL BRANCHES FROM WIRE.

1) PLACE MIN. ½" PVC PIPE AROUND EACH WIRE. EXPOSED WIRE SHALL BE MAX. 2" EACH SIDE (8) GROMMETED NYLON STRAPS (e)

TREE WRAP TO BE INSTALLED ONLY FROM OCTOBER 15
THROUGH APRIL 15. (DECIDUOUS (10) ) 6 FT. STEEL T-POST (SEE SCHEDULE). ALL SHALL BE DRIVEN OUTSIDE ROOTBALL AND IN UNDISTURBED SOIL. GALVANIZED WIRE, MIN. 12 GAUGE CABLE - TWIST WIRE ONLY TO KEEP FROM SLIPPING.

(2)

3" DEEP MULCH RING PLACED A MINIMUM OF 4 FT. IN DIAMETER. (DO NOT PLACE MULCH IN CONTACT WITH TREE TRUNK (FINISHED GRADE REFERENCES TOP OF MULCH). (12) (=) BACKFILL WITH BLEND OF
EXISTING SOIL AND A MAXIMUM
20% (BY VOLUME) ORGANIC
MATERIAL. WATER THOROUGHLY
WHEN BACKFILLING 4-6" HIGH WATER SAUCER IN NON-TURF AREAS.

1:1 SLOPE ON SIDES OF PLANTING (13) HOLE. PLACE ROOT BALL ON UNDISTURBED SOIL TO PREVENT SETTLEMENT.

PLACE SOIL AROUND ROOT BALL FIRMLY, DO NOT COMPACT OR TAMP. SETTLE SOIL WITH WATER TO FILL ALL AIR POCKETS. ROOT BALL AND TRUNK

(7)

(b)

REMOVE ALL TWINE, ROPE, BURLAP AND WIRE FROM ENTIRE

(5)

ANDSCAPE NOTES

OW THE LANDSCAPE PLANS AND SPECIFICATIONS AS IBSTITUTION OR ALTERATION SHALL NOT BE ALLOWED WNER'S REPRESENTATIVE. OVERALL PLANT QUANTITY AND

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WITHOUT APPROVAL OF THE OWNERS REPRESENTATIVE. OVERALL PLANT QUALITY AND QUALITY SHALL BE CONSISTENT WITH THE PLANS.

2. THE CONTRACTOR IS RESPONSIBLE FOR VERIFYING ALL PLANT QUANTITIES. GRAPHIC QUANTITIES TAKES PRECEDENCE OVER WRITTEN QUANTITIES.

3. THE CONTRACTOR IS RESPONSIBLE FOR VERIFYING ALL PLANT QUANTITIES. GRAPHIC QUANTITIES TAKES PRECEDENCE OVER WRITTEN QUANTITIES.

3. THE OWNERS REPRESENTATIVE RESERVES THE RIGHT TO INSPECT AND TAG ALL PLANT MATERIAL PRIOR TO SHIPPING TO THE SITE. IN ALL CASES, THE OWNERS REPRESENTATIVE MAY REJECT PLANT MATERIAL AT THE SITE IF MATERIAL IS DAMAGED, DISEASED, OR DECLINING IN HEALTH AT THE TIME OF ONSITE INSPECTIONS OR IF THE PLANT MATERIAL DOES NOT MEET THE MINIMUM SPECIFIC STANDARD IDENTIFIED ON THE PLANT MATERIAL DOES NOT MEET THE MINIMUM SPECIFIC OR SHALL COORDINATE WITH THE OWNER'S REPRESENTATIVE FOR INSPECTION AND APPROVAL OF ALL MATERIALS AND PRODUCTS PRIOR TO INSTALLATION.

4. THE OWNER'S REPRESENTATIVE FOR SHALL VERRIFY PLANT MATERIAL SIZES WITH OWNER'S REPRESENTATIVE FOR SHALL VERRIFY PLANT MATERIAL SIZES WITH OWNER'S REPRESENTATIVE FOR APPROVAL IF ADDITIONAL COST IS REQUESTED BY THE CONTRACTOR PRIOR TO INSTALLATION.

4. THE CONTRACTOR SHALL WARRANTY ALL CONTRACTOR PRIOR TO INSTALLATION.

5. THE CONTRACTOR SHALL WARRANTY ALL CONTRACTED WORK AND MATERIALS FOR A PERIOD OF ONE YEAR AFTER SUBSTANTIAL COMPLETION HAS BEEN ISSUED BY THE OWNER'S REPRESENTATIVE FOR APPROVAL IF ADDITIONAL COST SHALL FRIGATION BY THE ENTIRE PROJECT UNLESS OTHERWISE SPECIFIED IN THE CONTRACTOR SHALL FOR SHALL FRIGATION BY THE CONTRACTOR OF THE PROJECT ONE SHALL BRIGATION BE SEEN ISSUED BY THE CONTRACTOR SHALL FRIGATION BY THE CONTRACTOR OF THE ENTIRE PROJECT UNLESS OTHERWISE SPECIFIED IN THE CONTRACTOR OF THE ENTIRE PROJECT ONE SHALL BRIGATION BE SECONDATIONS AS STIPULATED IN THE GEOTECHNICAL REPORT.

5. THE CONTRACTOR SHALL FOUNDATIONS AS STIPULATED IN THE MINIMUM DISTANCE FILE FILE AND SCAPE. IN THE PROJECT OUTSIDE THE MINIMUM DISTANCE FILE FILE FILE FILE FILE FOR THE FILE FILE FILE FIL

THE LANDSCAPE CONTRACTOR SHALL BE RESPONSIBLE FOR ENSURING POSITIVE DRAINAGE EXISTS IN ALL LANDSCAPE AREAS. SURFACE DRAINAGE ON LANDSCAPE AREAS SHALL NOT FLOW TOWARD STRUCTURES AND FOUNDATIONS. MAINTAIN SLOPE AWAY FROM FOUNDATIONS PER THE GEOTECHNICAL REPORT RECOMMENDATIONS. ALL LANDSCAPE AREAS BETWEEN WALKS AND CURBS SHALL DRAIN FREELY TO THE CURB UNLESS OTHERWISE IDENTIFIED ON THE GRADING PLAN. IN NO CASE SHALL THE GRADE, TURF THATCH, OR OTHER LANDSCAPE MATERIALS DAM WATER AGAINST WALKS. MINIMUM SLOPES ON LANDSCAPE AREAS SHALL BE 2%; MAXIMUM SLOPE SHALL BE 25% UNLESS SPECIFICALLY IDENTIFIED ON THE PLANS OR APPROVED BY THE OWNER'S

REPRESENTATIVE.

9. PRIOR TO INSTALLATION OF PLANT MATERIALS, AREAS THAT HAVE BEEN COMPACTED OR DISTURBED BY CONSTRUCTION ACTIVITY SHALL BE THOROUGHLY LOOSENED TO A DEPTH OF 8" - 12" AND AMENDED PER SPECIFICATIONS.

10. ALL LANDSCAPED AREAS ARE TO RECEIVE ORGANIC SOIL PREPARATION AT 3 cu.yrds/1,000sf OR AS NOTED IN THE TECHNICAL SPECIFICATIONS.

11. TREES SHALL NOT BE LOCATED IN DRAINAGE SWALES, DRAINAGE AREAS, OR UTILITY EASEMENTS. CONTACT OWNER'S REPRESENTATIVE FOR RELOCATION OF PLANTS IN QUESTIONABLE AREAS PRIOR TO INSTALLATION.

12. ALL EVERGREEN TREES SHALL BE FULLY BRANCHED TO THE GROUND AND SHALL NOT EXHIBIT SIGNS OF ACCELERATED GROWTH AS DETERMINED BY THE OWNER'S

13. ALL TREES ARE TO BE STAKED AND GUYED PER DETAILS FOR A PERIOD OF 1 YEAR. THE CONTRACTOR SHALL BE RESPONSIBLE FOR REMOVING STAKES AT THE END OF 1 YEAR FROM ACCEPTANCE OF LANDSCAPE INSTALLATION BY THE OWNER'S REPRESENTATIVE. OBTAIN APPROVAL BY OWNER'S REPRESENTATIVE PRIOR TO REMOVAL.

14. TREE WRAP SHALL BE APPLIED IN LATE FALL AFTER INSTALLATION AND REMOVED THE FOLLOWING SPRING. TREES GREATER THEN 4" IN CALIPER MAY NOT REQUIRE TREE WRAP IF BARK IS SUFFICIENTLY DEVELOPED. OBTAIN APPROVAL FROM OWNER'S REPRESENTATIVE FOR ANY TREES THAT WILL NOT BE WRAPPED.

15. ALL SHRUB BEDS ARE TO BE MULCHED WITH MIN. 4" DEPTH, SHREDDED HARDWOOD LANDSCAPE MULCH OVER SPECIFIED GEOTEXTILE WEED CONTROL FABRIC. ALL GROUND COVER AND PERENNIAL FLOWER BEDS SHALL BE MULCHED WITH 3" DEPTH SHREDDED HARDWOOD LANDSCAPE MULCH. NO WEED CONTROL FABRIC IS REQUIRED IN GROUNDCOVER OR PERENNIAL AREAS.

16. EXISTING TURF AREAS THAT ARE DISTURBED DURING CONSTRUCTION, ESTABLISHMENT AND THE MAINTENANCE PERIOD SHALL BE RESTORED WITH NEW SOD TO MATCH EXISTING TURF SPECIES.

17. WHEN COMPLETE, ALL GRADES SHALL BE WITHIN +/- 1/8" OF FINISHED GRADES AS SHOWN ON THE PLANS.

KEVIN HERTZ MEMORIAL PLAYGROUND

VILLAGE OF ORLAND PARK, RECREATION & PARKS DEPT. ORLAND PARK, IL 708.403.6219 708.403.6289

Owner: **CENTENNIAL PARK** ORLAND PARK, IL

8/6/12 Bid Set

Issue Date

Revision

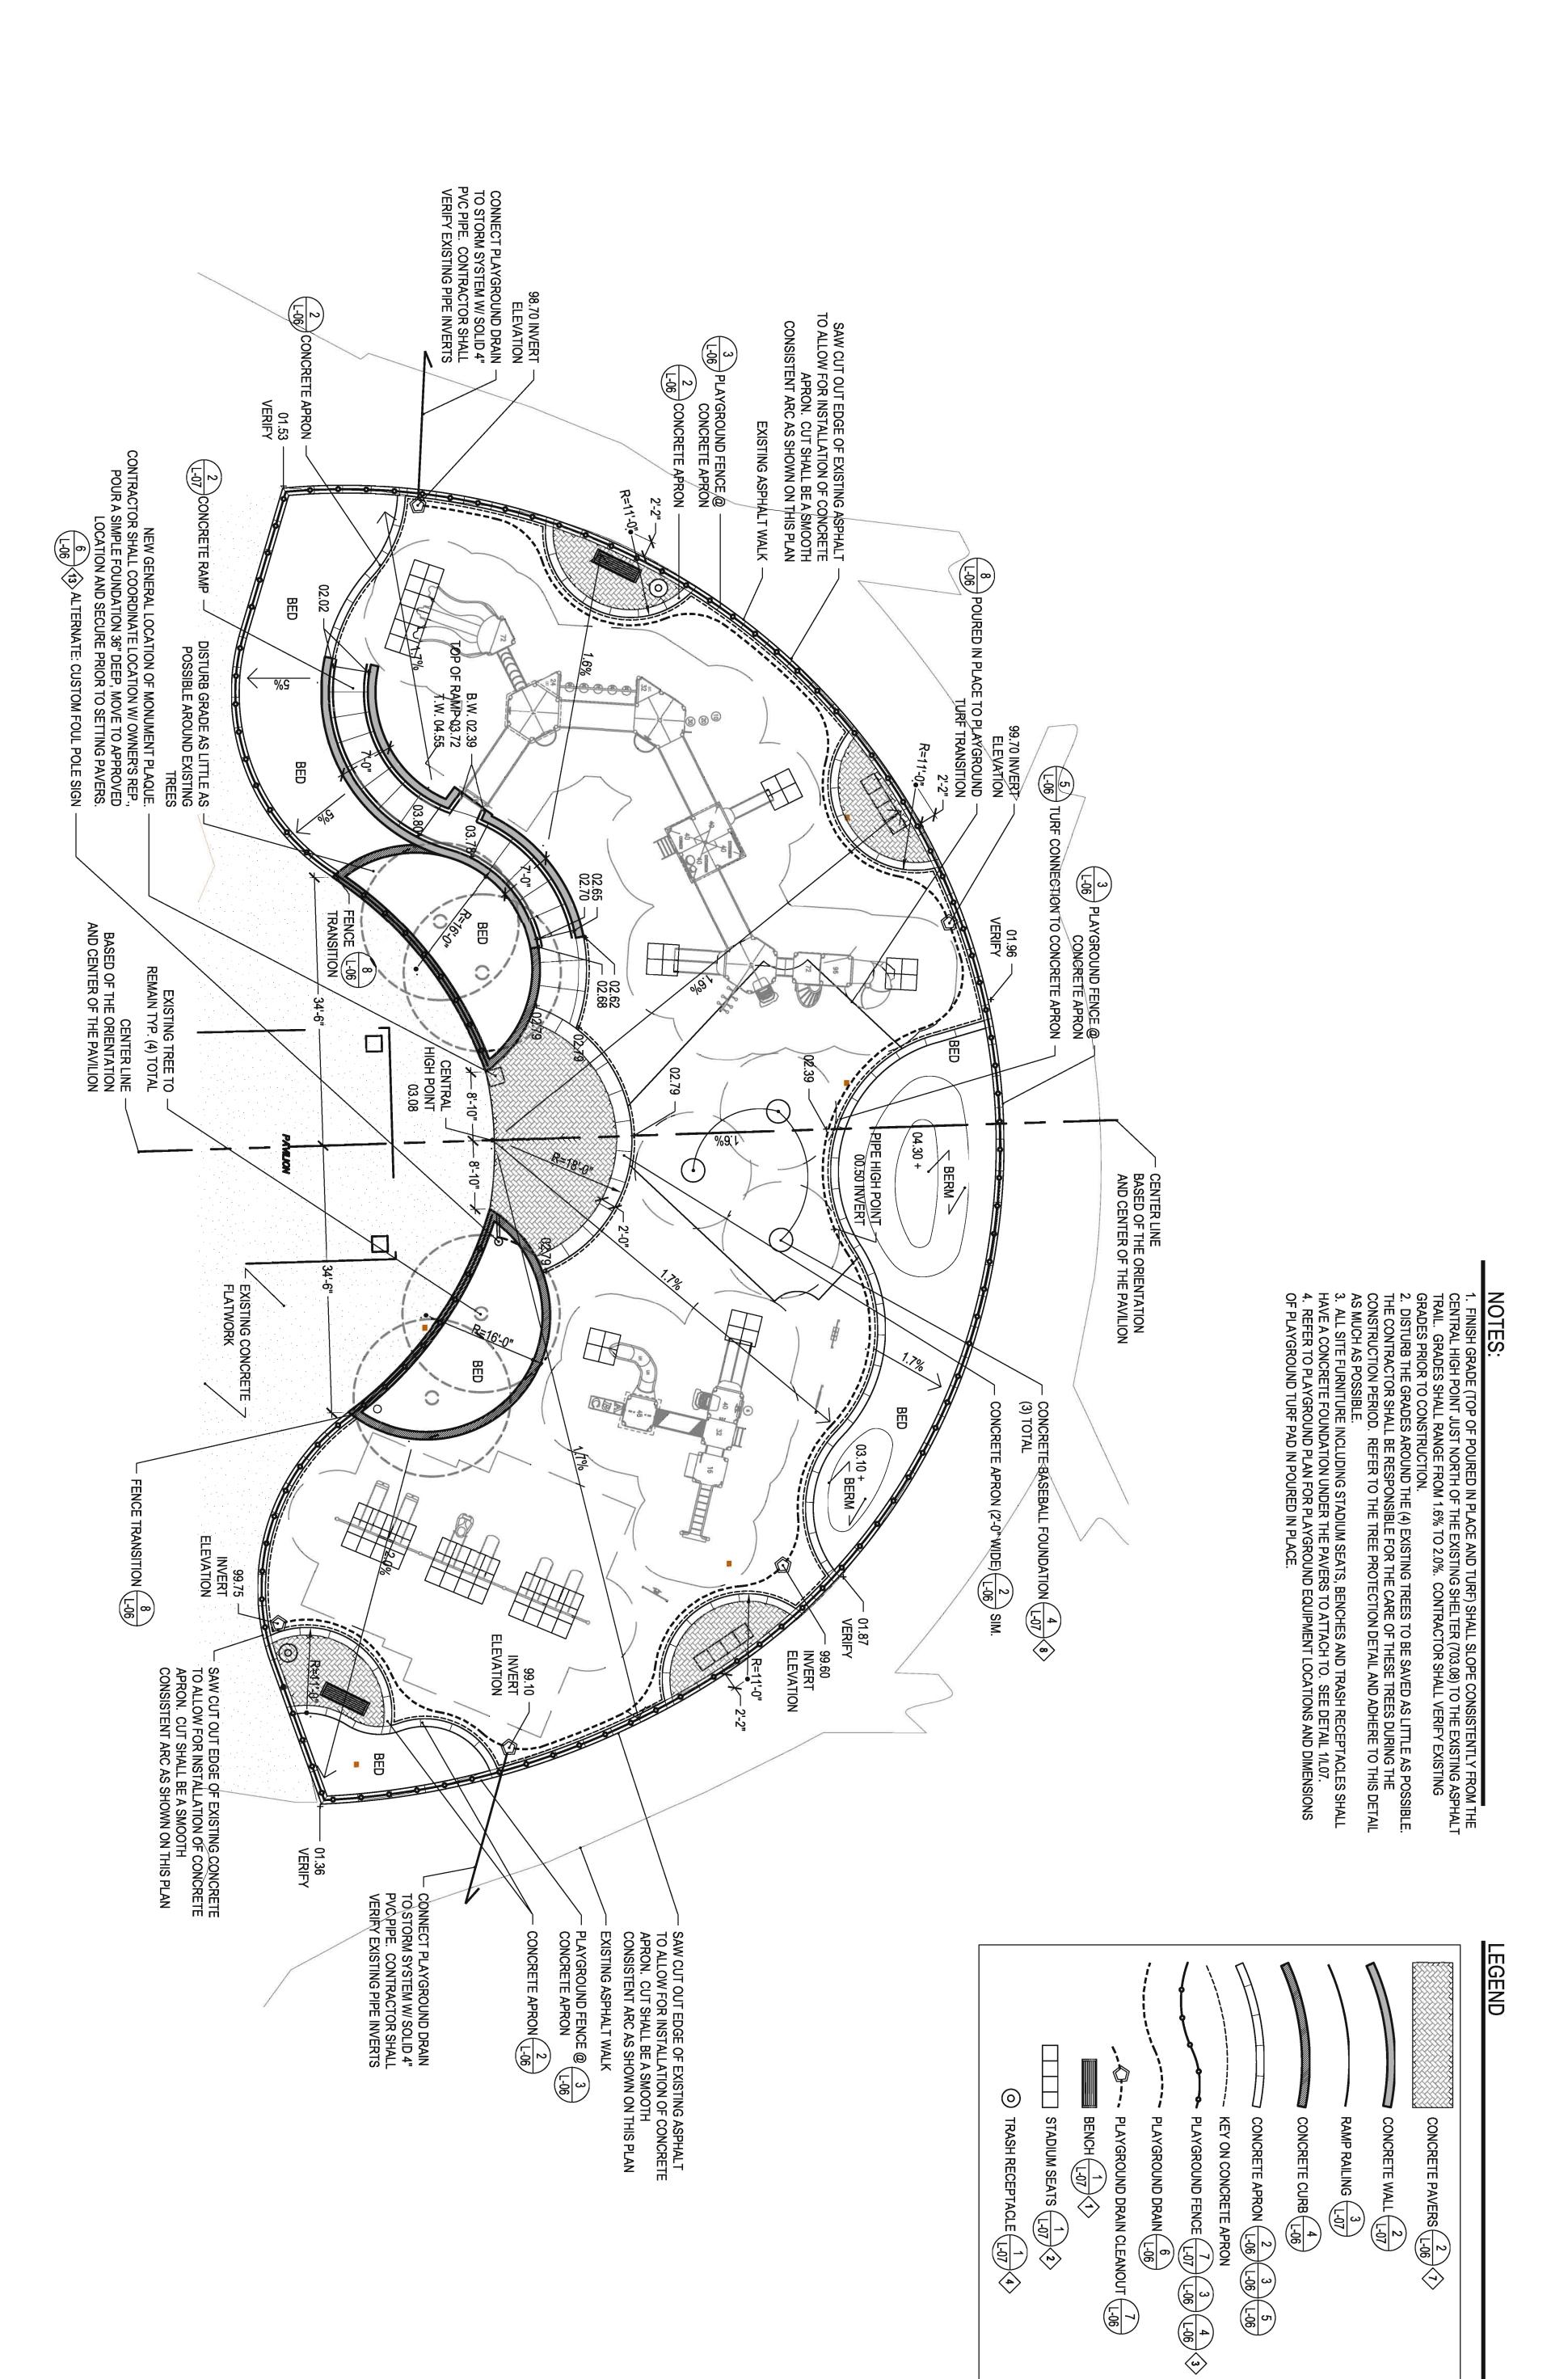
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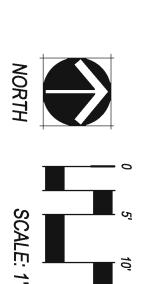
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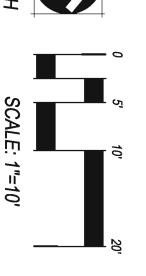
PLANTING DETAILS & NOTES

Sheet Number

L-02







GRADING & LAYOUT PLAN

Sheet Title

Sheet Number

L-03

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WALCH LITES

48 HOURS (2 working days) BEFORE YOU DIG

SCALE: 1"=10"

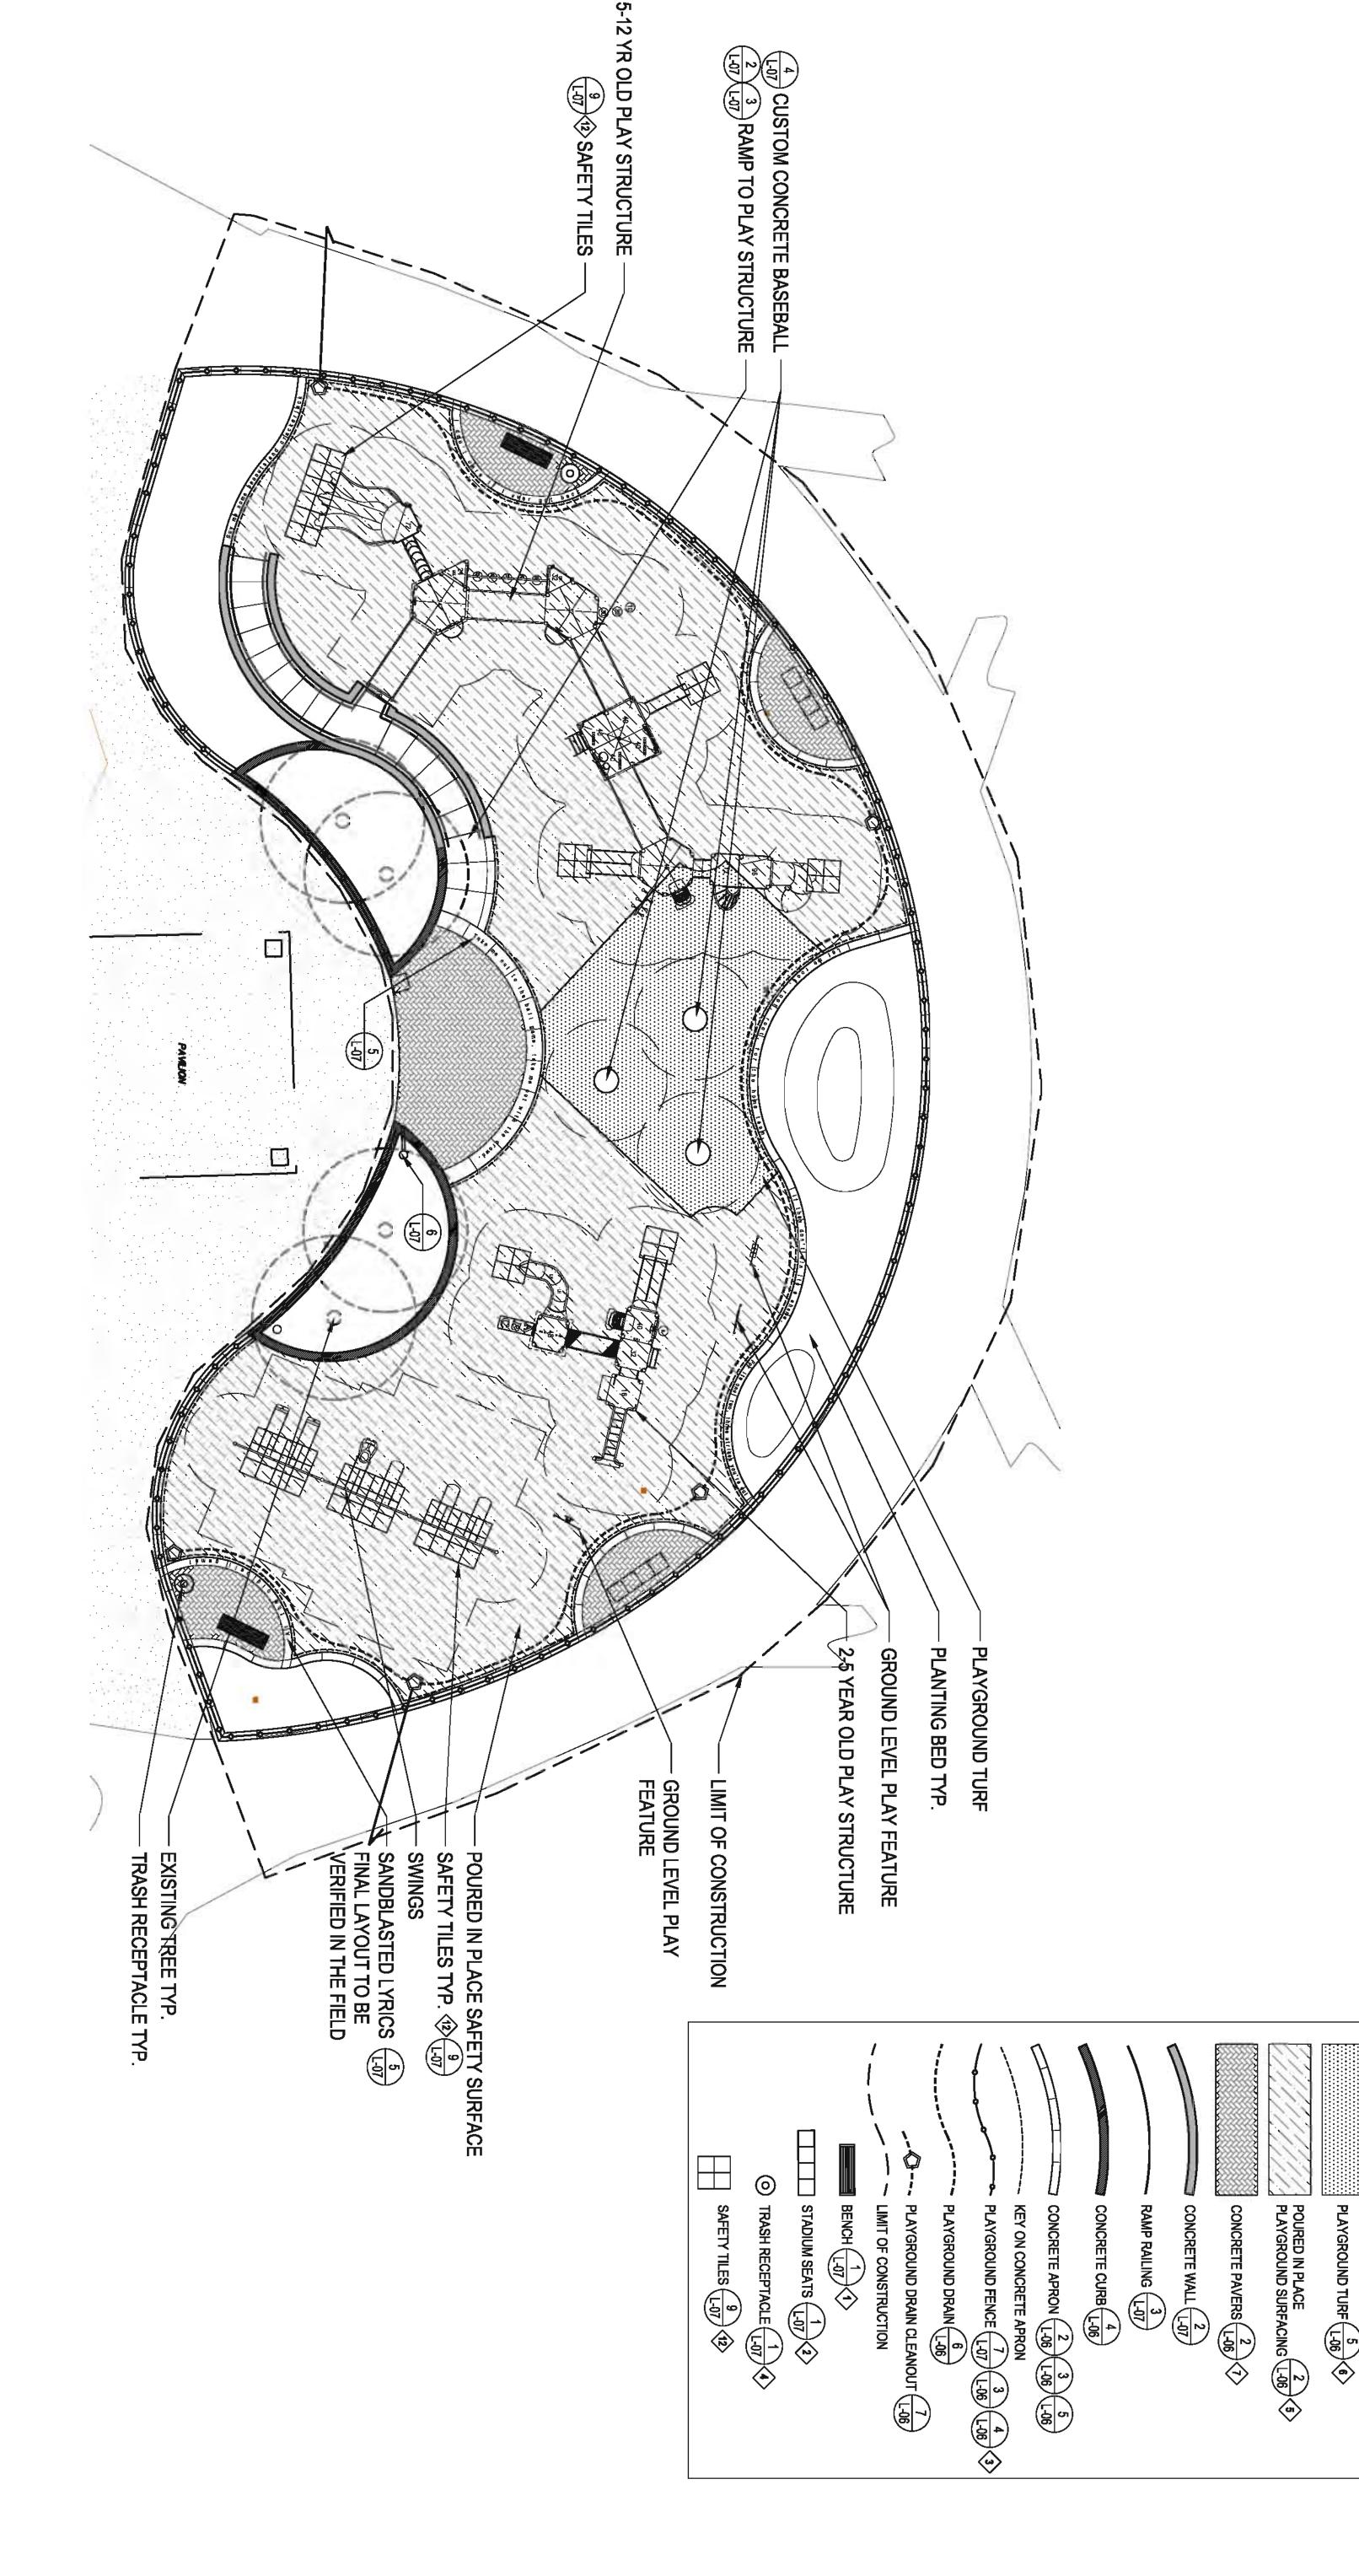
ONTACT JULIE AT 811 OR 800-892-0123
With the following:

PLAYGROUND PLAN

Sheet Title

Sheet Number

L-04



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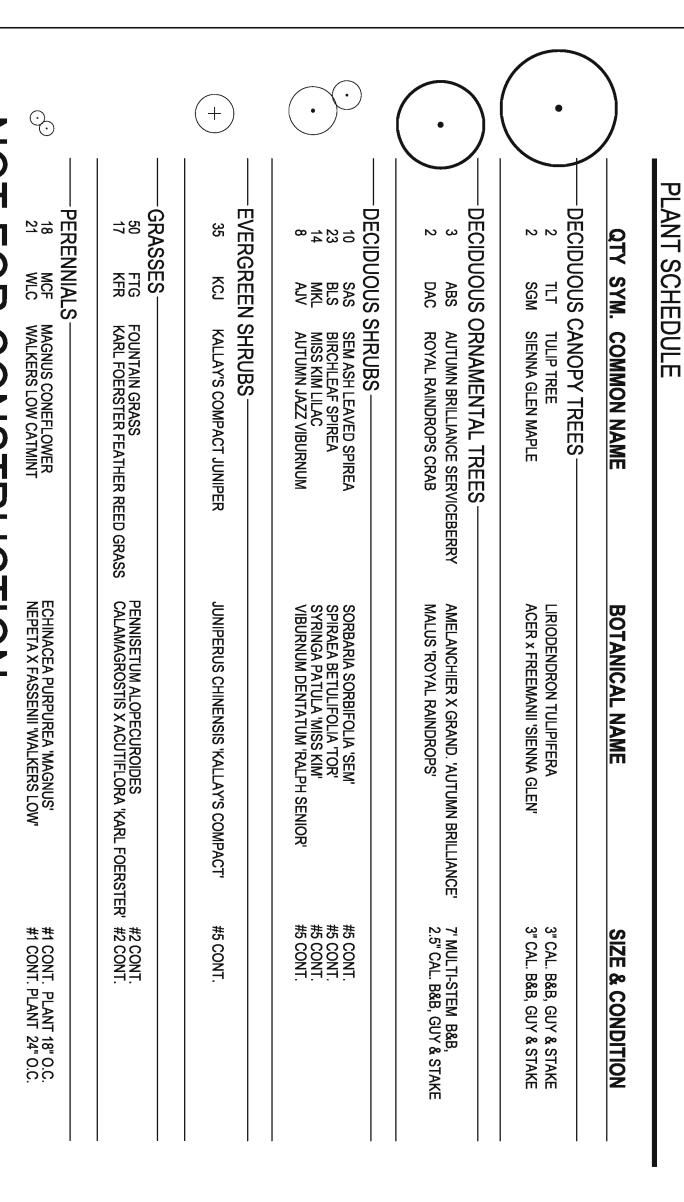
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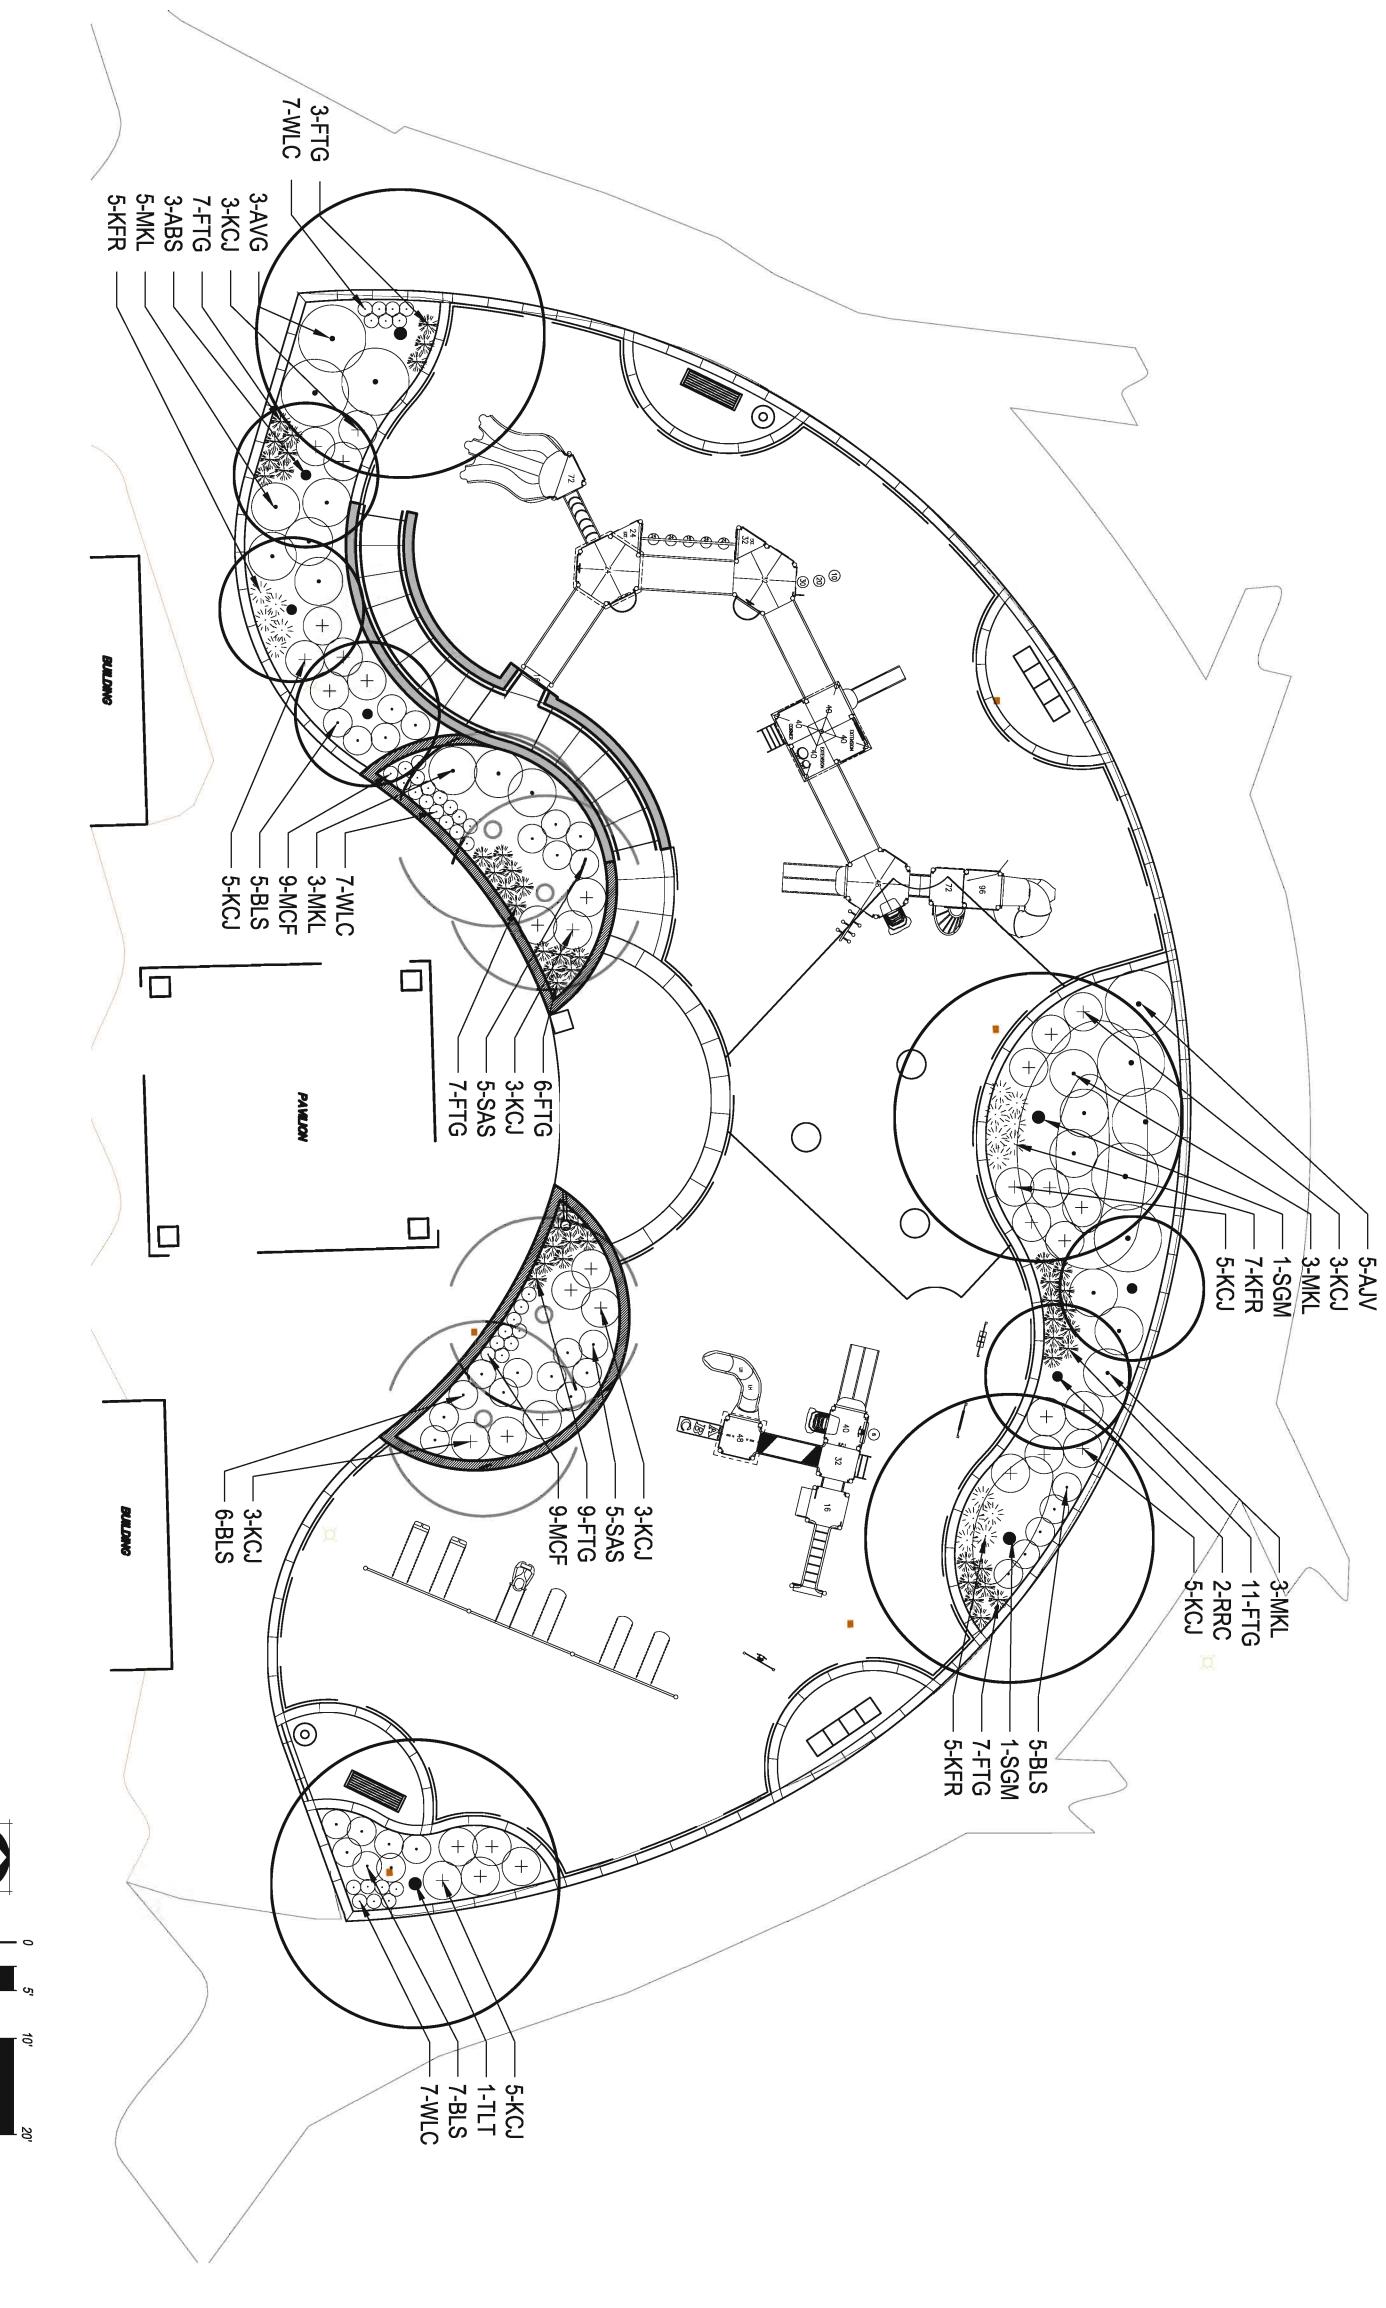
PLANTING PLAN & SCHEDULE


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L-05







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KEVIN HERTZ MEMORIAL PLAYGROUND

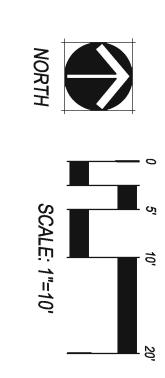CENTENNIAL PARK ORLAND PARK, IL

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PLAYGROUND DRAIN

7

PLAYGROUND DRAIN CLEANOUT

DEPTH WILL VARY, ENSURE ADEQUATE

(5)

ADJACENT CONCRETE APRON

(6)

(b)

**4" PVC ELBOW** 

**5** 

THREADED WATER TIGHT CAP

6" MIN.

ALLOW FOR ACCIDEVICES ON LID

**CESS TO OPENING** 

(e)

COMPACTED SUBGRADE

6" - 45 DEGREE PVC WYE FITTING

NOTE: CONFIRM FINAL GRADES PRIOR TO INSTALLING

(J

10" DIA. ROUND IRRIGATION BOX.
SET LID FLUSH W/ AGGREGATE
BASE, GLUE POURED IN PLACE
OUTO CAP, CREATE
HOLES IN POURED IN PLACE TO

WILL VARY

ω

4" DIA. PERFORATED PVC DRAIN PIPE - WRAP ENTIRE PIPE IN

MIRIFI 140N FILTER FABRIC

 $\bigcirc$ 

CA-7 DRAIN ROCK, WRAP ENTIRE TRENCH W/ MIRIFI 140N FILTER

**FABRIC** 

(-)

POURED IN PLACE SURFACING

SCALE: 3/4" = 1'-0"

4

CA-6 COMPACTED AGGREGATE

BASE COURSE, TOP OF BASE

COURSE SHALL SLOPE AT 1% MIN.

TO DRAIN

(2)

CA-7 DRAIN ROCK, WRAP ENTIRE TRENCH W/ MIRIFI 140N FILTER

**FABRIC** 

③ PLAYGROUND SURFACING

CLEANOUTS

PLAYGROUND FENCE

@ CONCRETE APRON

(J

<u>(-)</u>

4" DIA. PERFORATED PVC DRAIN PIPE, WRAP ENTIRE PIPE WITH MIRIFI 140N FILTER FABRIC. SLOPE PIPE AT 1% MIN, CONNECT TO STORM SYSTEM.

SCALE: 3/4" = 1'-0"

4

CONCRETE CURB W/ FENCE

3'-0" MIN

(G)

(e)

EXISTING ASPHALT WALK OR
CONCRETE. SAW CUT OUT
SMOOTH EDGE TO ALLOW FOR
CONCRETE APRON

(J

(7)

POURED IN PLACE SURFACING OR PLAYGROUND TURF

 $\bigcirc$ 

LANDSCAPE BED

POURED IN PLACE SURFACING, SEE DETAIL 2/L06

(-1)

(c)

COMPACTED SUBGRADE

(b)

(7)

CONCRETE FOOTER, HOLD 12"
LOW TO ALLOW FOR CONCRETE

(5)

(N)

(e)

6" DEPTH COMPACTED CA-6 AGGREGATE UNDER CURB

**(5)** 

(4) #4 REBAR CONTINUOUS

4

1/2" CHAMFERED REVEAL AROUND ALL EXPOSED SIDES OF THE CURB

(b)

COMPACTED SUB-GRADE PER GEOTECNICAL REPORT RECOMMENDATIONS

(5)

CONCRETE FOOTER, HOLD 12"
LOW TO ALLOW FOR CONCRETE

ယ

7

8

4

KEY IN APRON TO RECEIVE
PLAYGROUND TURF OR POURED
IN PLACE. KEY IS NOT NEEDED
) WHEN APRON IS NOT ADJACENT
TO PLAYGROUND TURF OR
POURED IN PLACE, APRON SHALL
BE 12" WIDE

3

ω

CUT SCORE JOINTS 4' O.C., CENTERED ON FENCE POST, 1/8" RADIUS ON ALL EXPOSED EDGES

 $\odot$ 

1/2" SEALED EXPANSION JOINT MATERIAL

(G)

(51

6

 $\bigcirc$ 

(-)

PLAYGROUND TURF w/ MANUFACTURER SPECIFIED INFILL

SCALE: 1-1/2" = 1'-0"

PLAYGROUND CONCRETE 10" CURB, PROVIDE 1/8" WIDE SAW

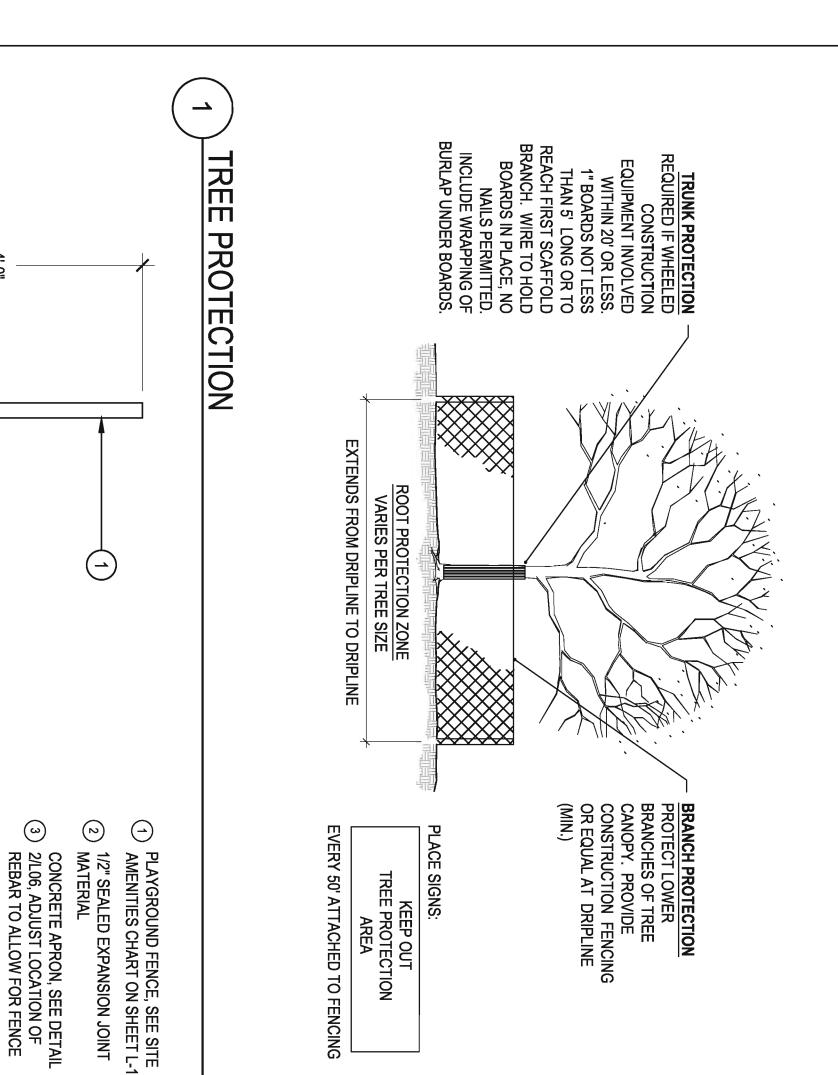
<u>-</u>

PLAYGROUND FENCE, SEE SITE AMENITIES CHART ON SHEET L-1

SCALE: 1/8" = 1'-0"

(N

FOR CONSTRUCTION



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REFER

1. ALL TRE TO PREV WITHIN TREE AN TRENCH WHEN II EE PROTECTION NOTES

ALL TREES AND SHRUBS TO BE PROTECTED AND PRESERVED SHALL BE DETAIL. GROUPING OF MORE THAN ONE TREE MAY OCCUR. TREES AND SHRUBS TO BE PROTECTED AND PRESERVED SHALL BE IDENTIFIED ON THE TRUNK WITH WHITE SURVEY TAPE. TO PREVENT ROOT SMOTHERING, SOIL STOCKPILES, SUPPLIES, EQUIPMENT OR ANY OTHER MATERIAL SHALL NOT BE PLACED OR STORED WITHIN THE DRIP LINE OR WITHIN 15 FEET OF A TREE OR SHRUB TRUNK, WHICHEVER IS GREATER.

TREE AND SHRUB ROOTS SHALL NOT BE CUT UNLESS CUTTING IS UNAVOIDABLE.

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TREE AND SHRUB ROOTS SHALL NOT BE CUT UNLESS CUTTING IS UNAVOIDABLE.

TREE AND SHRUB ROOTS SHALL BE COVERED TO PREVENT DEHYDRATION.

WHEN IN CLOSE PROXIMITY TO LOW BRANCHING TREES. WHENEVER POSSIBLE, ROOTS TWO INCHES OR GREATER IN DIAMETER SHALL BE TUNNIBLED OR BORED UNDER AND SHALL BE COVERED TO PREVENT DEHYDRATION.

WHEN ROOT CUTTING IS UNAVOIDABLE, A CLEAN SHALL BE COVERED WITH SOIL DE CUT BETWEEN LATE FALL AND BUD OPENING, WHEN ROOT ENERGY STALL BE COVERED WITH SOIL OR BURLAP AND KEPT MOIST.

WHEN ROOT ENERGY STALL BE COVERED WITH SOIL OR BURLAP AND KEPT MOIST.

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WHEN ROOT ENERGY STALL BE COVERED WITH SOIL OR BURLAP AND KEPT MOIST.

WHEN ROOT ENERGY STALL BE COVERED WITH SOIL OR

(-)

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10. FENCIN

6" MIN WILL VARY 6" MIN. 4  $(\omega)$ 1<u>-</u>0 (5) (G) 6" MIN. (b) ω (2)KEY TO RECEIVE POURED IN PLACE SURFACING. COORDINATE DEPTH OF KEY (SEE NOTE 1). KEY IS NOT NEEDED WHEN APRON IS NOT ADJACENT TO PLAYGROUND TURF OR POURED IN PLACE, APRON SHALL BE 12" WIDE POURED IN PLACE SURFACING DEPTH WILL VARY, CONTRACTOR
SHALL COORDINATE W/ PLAYGROUND
MANUFACTURER AND POURED IN
PLACE PROVIDER TO SET DEPTHS CONCRETE APRON W/ #4 REBAR
CONTINUOUS. ALL EXPOSED EDGES
) SHALL HAVE A 1/2" RADIUS. SAW CUT
SCORE JOINTS SHALL BE SPACED 4'
O.C. AND WRAP TOP AND SIDES. SAND SET CONCRETE PAVERS - INSTALL PER MANUFACTURERS SPECIFICATIONS **COMPACTED CA-6 AGGREGATE** 

IG MATERIAL SHALL BE BRIGHT, CONTRASTING COLOR, DURABLE, AND A MINIMUM OF FOUR FEET IN HEIGHT.

IG MATERIAL SHALL BE SET AT THE DRIP LINE OR 15 FEET FROM TREE TRUNK, WHICHEVER IS GREATER, AND MAINTAINED IN AN UPRIGHT

IN THROUGHOUT THE DURATION OF CONSTRUCTION ACTIVITIES.

IG TREES TO REMAIN. RETAINING WALLS AND TREE WELLS ARE ACCEPTABLE ONLY WHEN CONSTRUCTED PRIOR TO GRADE CHANGE.

### NOTE: REFER TO SITE AMENITIES CHART FOR TYPE OF CONCRETE PAVER AND POURED IN PLACE SURFACING

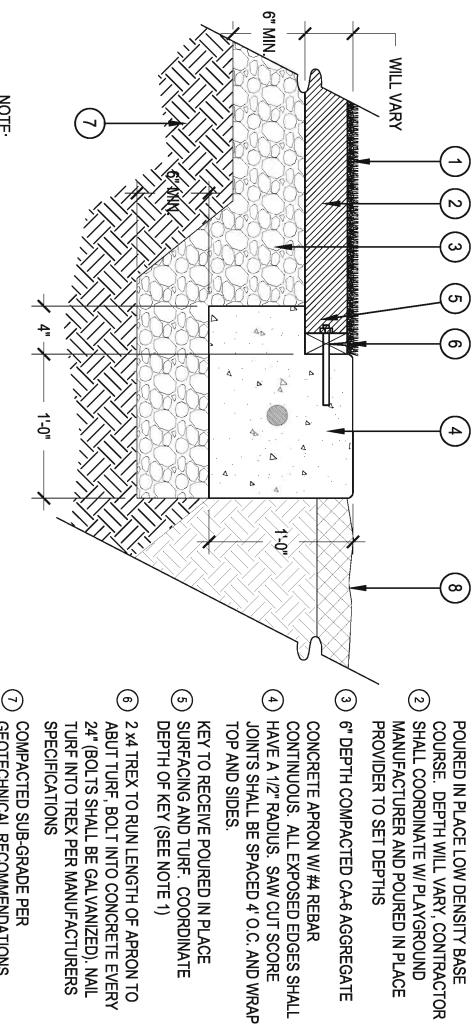
CONCRET

(7)

SAND SETTING BED

COMPACTED SUB-GRADE PER GEOTECHNICAL RECOMMENDATIONS

### E APRON, POURED IN PLACE, CONCRETE PAVERS




NOTE: REFER TO SITE AMENITIES CHART FOR TYPE OF CONCRETE PAVER AND POURED IN PLACE SURFACING (e)

CONCRETE APRON W/ #4 REBAR
CONTINUOUS. ALL EXPOSED EDGES SHALL

A) HAVE A 1/2" RADIUS. SAW CUT SCORE
JOINTS SHALL BE SPACED 4' O.C. AND WRAP
TOP AND SIDES. 2 x4 TREX TO RUN LENGTH OF APRON TO ABUT TURF, BOLT INTO CONCRETE EVERY 24" (BOLTS SHALL BE GALVANIZED). NAIL TURF INTO TREX PER MANUFACTURERS SPECIFICATIONS ADJACENT LANDSCAPE BED OR CONCRETE FLATWORK COMPACTED SUB-GRADE PER GEOTECHNICAL RECOMMENDATIONS KEY TO RECEIVE POURED IN PLACE SURFACING AND TURF. COORDINATE DEPTH OF KEY (SEE NOTE 1)

TURF & CONNECTION TO CONCRETE APRON

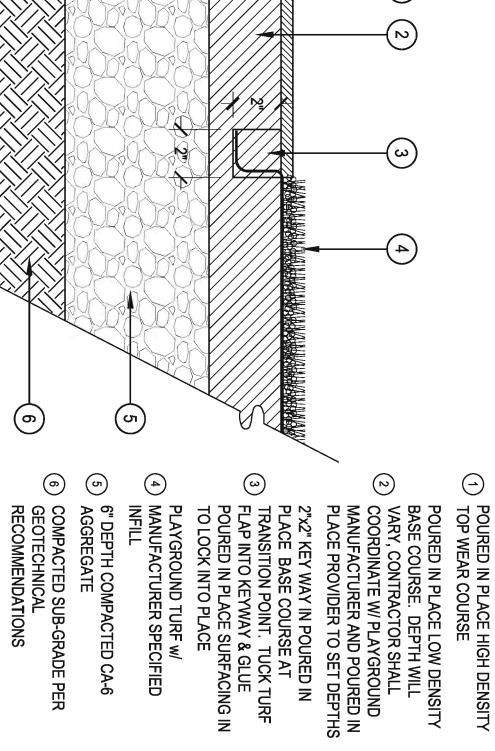SCALE: 1-1/2" = 1'-0"



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HERTZ MEMORIAL PLAYGROUND

CENTENNIAL PARK ORLAND PARK, IL

VILLAGE OF ORLAND PARK, RECREATION & PARKS DEPT. ORLAND PARK, IL 708.403.6219 708.403.6289 Owner:

**DETAILS** 

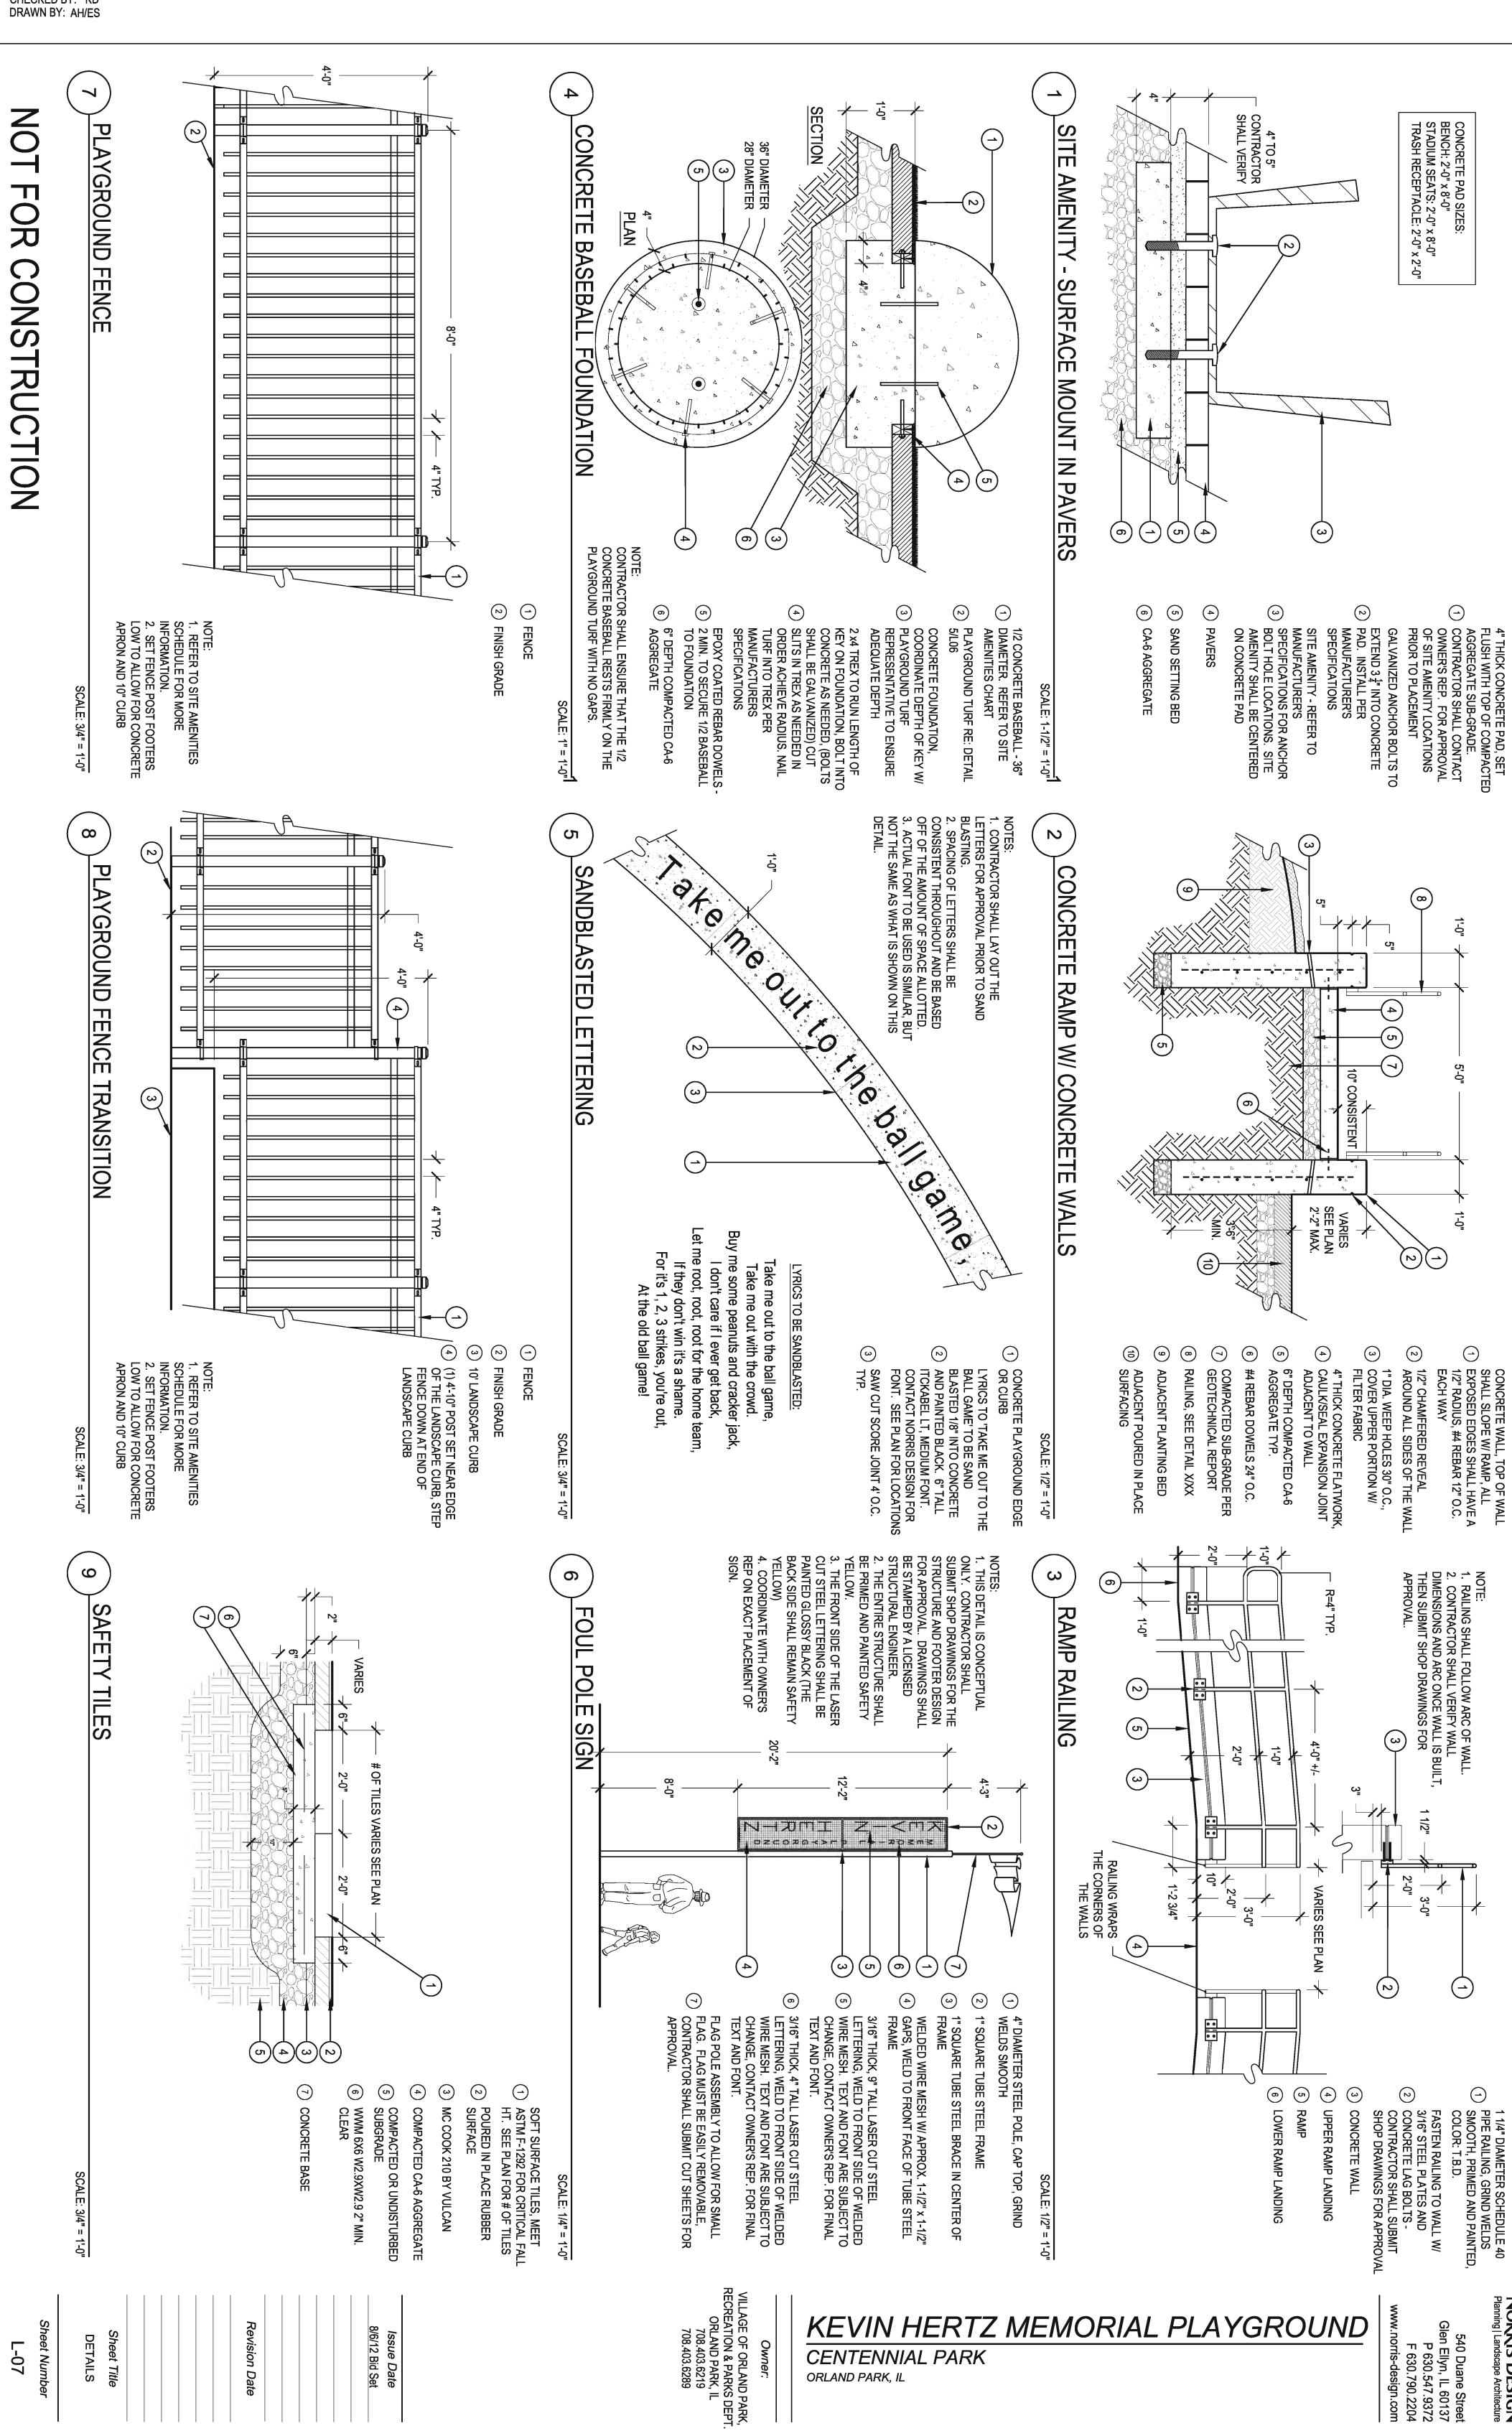
NOTE:
REFER TO SITE AMENITIES CHART FOR TYPE
OF TURF AND POURED IN PLACE SURFACING

POURED IN PLACE TO TURF TRANSITION

**L-06** 

-07

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